SIGNAGE SCHEDULE 1 | & **UTILITY ROOM WOMENS** 24414444444 EXX41.44 **.### 60" MAX **WOMENS ROOM** UTILITY ROOM MENS ROOM SPACE #103 SPACE # 102 SPACE #104 6" x 6" 3" x 6" 6" x 6" ADA COMPLIANT SIGNAGE MOUNTING HEIGHT

ATER SCH	EDULE
UH # 1,2,3	UH # 4
CLG MTD	CLG MTD
SEE PLANS	SEE PLANS
17.1	17.1
5.0	5.0
208 / 1 / 60	208 / 1 / 60
DIRECT	DIRECT
4.25	245
NEG.	NEG.
208 / 1 / 60	208 / 1 / 60
24V	24V
NOTE 1,2	NOTE 1,2,4
MARKEL	MARKEL
F3485	F3425
	UH # 1,2,3 CLG MTD SEE PLANS 17.1 5.0 208 / 1 / 60 DIRECT 4.25 NEG. 208 / 1 / 60 24V NOTE 1,2 MARKEL

- . FLUSH MOUNTED WITH INTEGRAL DISCONNECT SWITCH. CEILING FIXTURES - SUPPORT FROM
- STRUCTURE ABOVE CEILING.
- 2. PROVIDE REMOTE PROGRAMABLE THERMOSTAT IN UTILITY ROOM WITH REMOTE SENSING BULB.
- 3. PROVIDE MOTOR STARTER WHERE REQUIRED OR NECESSARY.
- 4. PROVIDE WALL BRACKET.

EXHAUS'	T FAN SCH	IEDULE
EQUIPMWENT No.	EF#1	
TYPE	IN-LINE	
SERVICE	SEE PLANS	
CFM	900	
STATIC PRESSURE	375"	
SONES	3.8	
HP	387 WATTS	
VOLTAGE	120/1/60	
ACCESSORIES	NOTE1,2	
DAMPER TYPE	BACKDRAFT	
SCREEN TYPE		
MANUFACTURER	соок	
MODEL NUMBER	ON-840	

INTERLOCK FAN WITH LIGHT.

	REDUCED PRESSU	JRE BAC	KFLO	W PRE	VENTE	R SCHEDU	JLE
RPBP#	MANUFACTURER	MODEL#	QTY.	SIZE	GPM	PRESS. DROP	SERVING
P-9	WATTS	LF 909 OT	1	2 INCH	175	10 PSIG	DOM. WTR.

	FIXTURE CONNECTION SCHEDULE					
P-#	DESCRIPTION	C.W. (IN.)	H.W. (IN.)	WASTE (IN.)	VENT (IN.)	NOTES
P-1	WATER CLOSET (WALL MOUNTED, HANDICAP ACCESSIBLE)	1	ı	4	2	1,2,5
P-2	WATER CLOSET (WALL MOUNTED)	1		4	2	1,2,5
P-3	URINAL	3/4		4	2	1,2,5
P-4	LAVATORY	1/2	1/2	11⁄4	11/4	1,2,3,5
P-5	LAVATORY	1/2	1/2	11/4	11/4	1,2,3,5
P-6	FLOOR DRAIN			4	2	4,5
P-7	DRINKING FOUNTAIN	1/2		11/4	11/4	
P-8	WALL HYDRANT	3/4				4,5

- EQUALS BY ELJER. KOHLER. CRANE OR APPROVED EQUAL.
- 2. PROVIDE 18" HIGH AIR CHAMBERS.
- 3. PROVIDE INSULATE WASTE & WATER WITH TRUEBRO HANDI LAV-GUARD SYSTEM FOR ALL ACCESSIBLE LAVATORIES.
- 4. EQUALS BY ZURN, J.R. SMITH, WADE,
- . ALL FIXTURES TO BE APPROVED BY OWNER

PLUMBING FIXTURE SCHEDULE

P-1 WATER CLOSET (HANDICAP ACCESSIBLE)

AMERICAN STANDARD #3461.712, FLOOR MOUNTED AT 17" AFF, VITREOUS CHINA, 1-1/2" TOP-SPUD, ELONGATED RIM TOILET; ZURN 3ZEMS6153AV-HET-HW6-MJ SENSOR W/ CONCEALED FLUSH VALVE (1.28 GPF). PUSH BUTTON CANNOT BE MORE THAN 36" AFF; CENTOCO #500CCSS OPEN FRONT SEAT WITH COVER, ZURN #P6000-HW6 POWER CONVERTER.

AMERICAN STANDARD #3451.712 FLOOR MOUNTED. VITREOUS CHINA, 1-1/2" TOP-SPUD, ELONGATED RIM TOILET; ZURN #ZEMS6153AV-HET-HW6-MJ SENSOR W/ CONCEALED FLUSH VALVE (1.28GPF) PUSH BUTTON CAN NOT BE MORE THAN 39" AFF; CENTOCO #5000CSS OPEN FRONT SEAT LESS COVER. ZURN #P6000-HWS POWER CONVERTER.

P-3 URINAL (WALL MTD, HANDICAP ACCESSIBLE)

AMERICAN STANDARD #6400.014 WALL-MOUNTED, VITREOUS CHINA, ¾" TOP SPUD, URINAL; ZURN #ZEMS8107AV-EWS-HW6-MJ SENSORN W/CONCEALED FLUSH VALVE(.5 GPF). MCGUIRE #H2133 STRAINER. ZURN #P6000-HW6 POWER CONVERTER.

P-4 LAVATORY (HANDICAP ACCESSIBLE)

AMERICAN STANDARD #0355.012 WALL MOUNTED AT 34" AFF VITREOUS CHINA WITH FLOOR MOUNTED WALL HANGER (PROVIDE ZURN #Z-1231-SL FOR 8" BLOCK WALL); ZURN #Z6915-XL-J-HW6-CWB-TMV-1 SENSOR FAUCET, POLISHED CHROME-PLATED, FAUCET HOLES 4" ON CENTER; MCGUIRE #155WC OFFSET HANDICAP GRID DRAIN, MCGUIRE#H-2165LK SUPPLY PIPES, STOP VALVES AND P-TRAP. ZURN #P6000-HW6 POWER CONVERTER THERMOSTATIC MIXING VALVE.

P-5 LAVATORY

AMERICAN STANDARD #0355.012 WALL MOUNTED AT 34" AFF, VITREOUS CHINA WITH FLOOR MOUNTED WALL HANGER (PROVIDE ZURN #Z-1231-SL FOR 8" BLOCK WALL); ZURN #Z6915-XL-J-CWB-TMV-1 SENSOR FAUCET, POLISHED CHROME PLATED. FAUCET HOLES 4" ON CENTER; MCGUIRE #155A GRID DRAIN; MCGUIRE #H-2165LK SUPPLY LINES, STOP VALVES AND P-TRAP. ZURN #P6000-HW6 POWER CONVERTER. THERMOSTATIC MIXING VALVE.

J.R. SMITH #2005 DUCO CAST IRON BODY WITH FLASHING COLLAR AND ADJUSTABLE STRAINER. PROVIDE TRAP PRIMER

P-7 SITE DRINKING FOUNTAIN (HANDICAP ACCESSIBLE, HI/LOW) MOST DEPENDABLE FOUNTAIN 400 SERIES, STAINLESS STEEL TOP AND BODY, WITH VANDAL RESISTANT KIT, PROVIDE STOP, SUPPLY, TRAP, ETC. TO MAKE A COMPLETE INSTALLATION, ½" C.W., 1½" SAN. MOUNT 33" LOW TO SPOUT AND 38"

P-8 WALL HYDRANT WITH BOX AND DOOR. PROVIDE VACUUM BREAKER WITH WALL HYDRANT.

ROCK ISLAND STATE PARK

RESTROOM RENOVATIONS

PREPARED FOR:

TENNESSEE DEPARTMENT OF ENVIRONMENT AND CONSERVATION TENNESSEE STATE PARKS

Sheet List Table

Sheet Number	Sheet Title
A0.00	COVER
A0.01	GENERAL NOTES
A0.02	SPECIFICATIONS 1
A0.03	SPECIFICATIONS 2
A2.1	FLOOR PLAN - ELEVATIONS - NOTES - DOOR SCHEDULE
A2.2	SECTIONS - DETAILS - RCP
A2.3	FOUNDATION PLAN - SECTIONS - DETAILS

OWNER / DEVELOPER

TENNESSEE ENVIRONMENT AND CONSERVATION DEPARTMENT 401 CHURCH STREET NASHVILLE, TN 37243 (615) 532-0109


DESIGNER

LOSE & ASSOCIATES, INC

LANDSCAPE ARCHITECTURE/ARCHITECTURE/CIVIL ENGINEERING/PLANNING

> 1314 5TH AVENUE NORTH, SUITE 200 NASHVILLE, TENNESSEE 37208 PHONE: 615-242-0040 CONTACT: MATTHEW CRAMER, AIA


LOCATION MAP

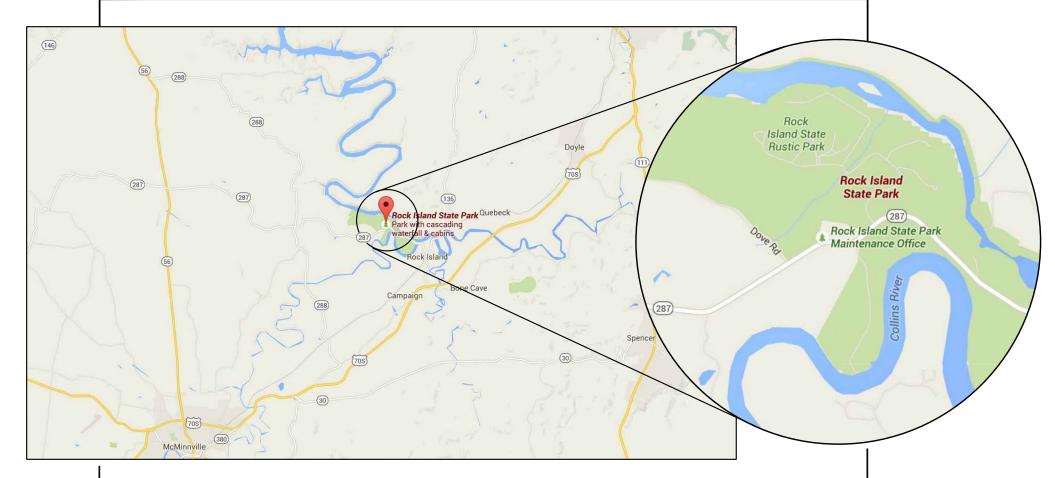

PARK OFFICE

82 BEACH RD. ROCK ISLAND, WARREN COUNTY, **TENNESSEE 38581** (931) 686-2471

1314 5th Avenue North, Suite 200 Nashville, Tennessee 37208 (615) 242-0040

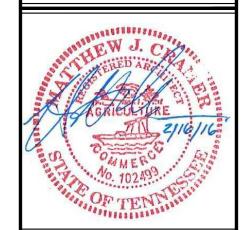

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ROCK STROOM F

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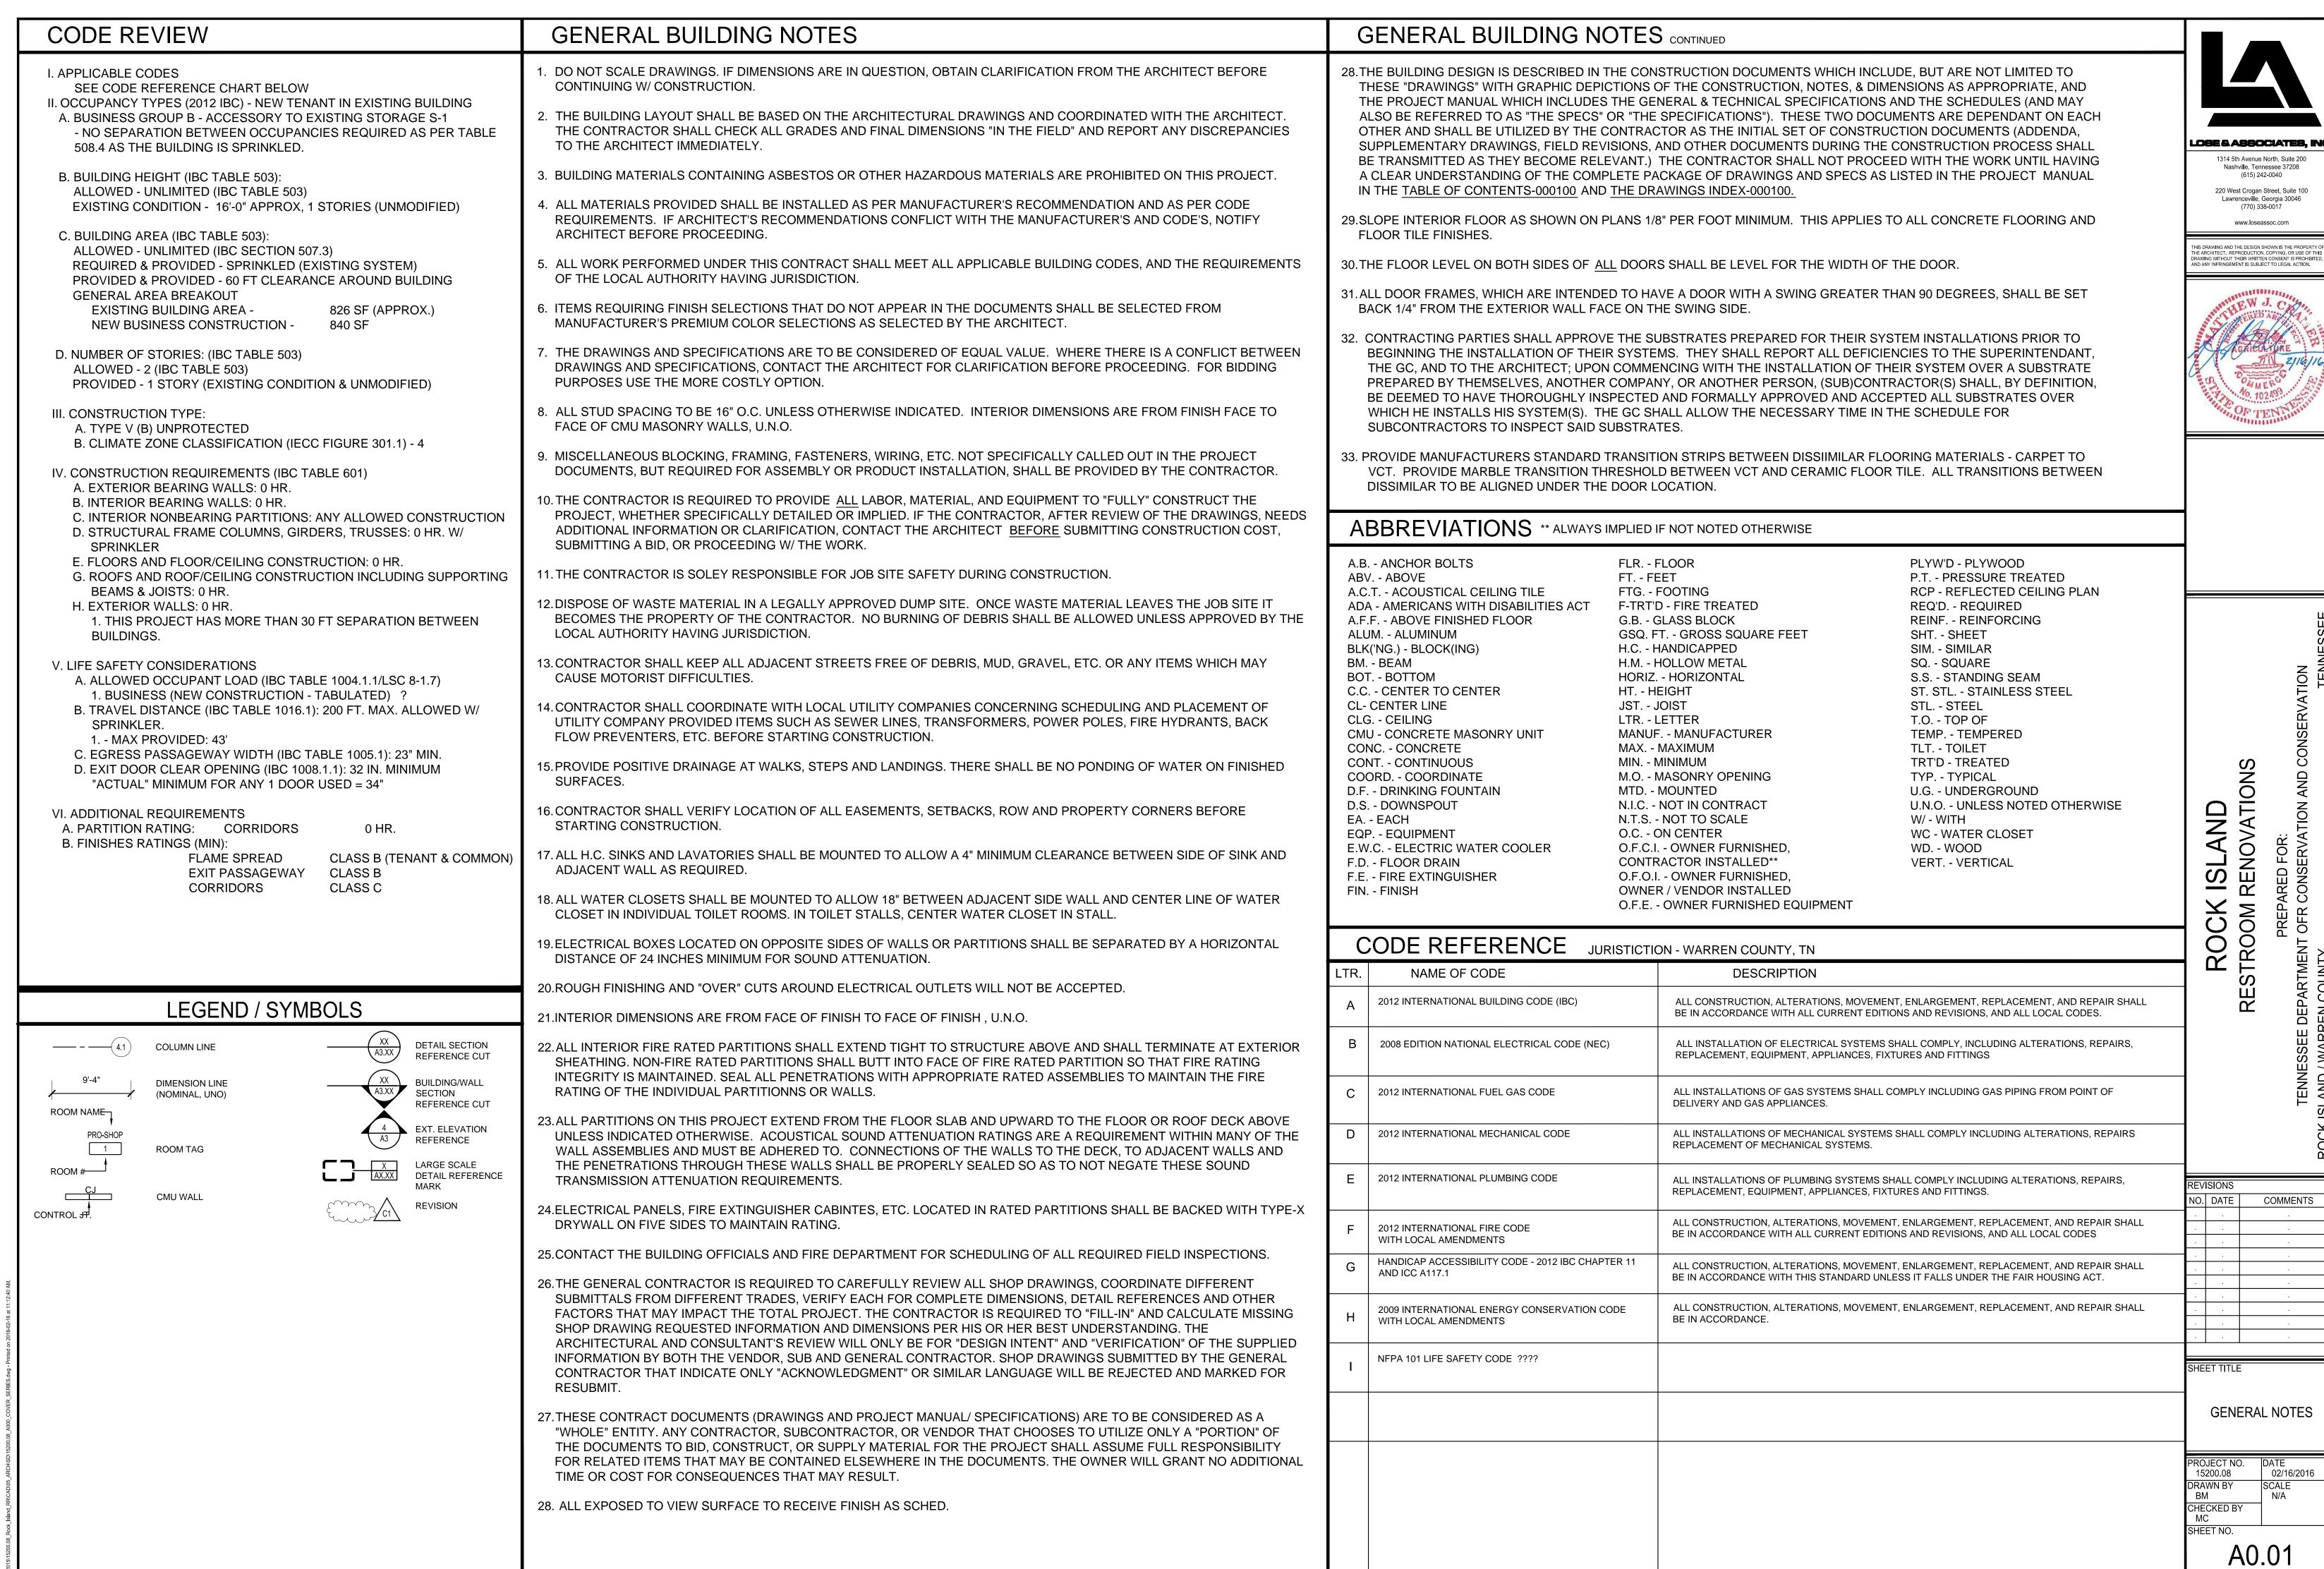
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02/16/2016 DRAWN BY

COVER SHEET

SHEET NO. A0.00

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PROJECT SPECIFICATIONS

SECTION 010600 REGULATORY REQUIREMENTS

- 1.1 REFER TO DRAWING A0.0 FOR ALL APPLICABLE AND GOVERNING CODES.
 - 1.1.1 CONTRACTOR SHALL PAY, CONTRACT FOR & PROVIDE ALL NECESSARY
 - 1.1.2 COPY A/E AND CM WITH ALL TEST RESULTS.

SECTION 013000 SUBMITTALS

TESTING

- 1.1 SUBMIT ALL SUBMITTALS W/IN SIXTY (60) DAYS OF NOTICE TO PROCEED.
- 1.2 CONTRACTOR SHALL VERIFY EACH SUBCONTRACTOR'S SAMPLES, SHOP DRAWINGS & OTHER I TEMS FOR COMPLIANCE WITH THE CONTRACT DOCUMENTS & SHALL FORWARD TO THE A/E w/ THE FOLLOWING:
 - 1.2.1 PROJECT NAME
 - 1.2.2 DATE SUBMITTED
 - 1.2.3 IDENTIFY SPECIFICATION NO.
 - 1.2.4 SUBCONTRACTOR'S, SUPPLIERS, MFR.'S NAME & CONTACT INFO.
 - 1.2.5 NOTIFICATIONS OF DEVIATIONS FROM CONTRACT DOCUMENTS
 - 1.2.6 CONTRACTOR'S STAMP & REVIEW DATA
 - 1.2.7 MSDS SHEETS FOR PRODUCTS & COMPONENTS (OSHA 1910.1200,8-24, 1987) FOR ALL 'HAZARDOUS' CONSTRUCTION PRODUCTS.
 - 1.2.8 MANUFACTURER'S INSTALLATION INSTRUCTIONS INCLUDING
 - PREPARATION BY OTHERS 1.2.9 MANUFACTURER'S PROTECTION REQUIREMENTS MANUFACTURER'S
 - MAINTENANCE INSTRUCTIONS
 - 1.2.10 PRODUCT DATA, ILLUSTRATIONS, STD. SCHEDULES, DIMENSIONS, DIAGRAMS, COMPLIANCE w/ REF. STDS. (ASTM, UL)
 - 1.2.11 REQUIRED CLEARANCE DIMENSIONS, WIRING & CONTROL DIAGRAMS
 - 1.2.12 NOTE VARIANCES INCLUDING PIPING AND CONTROLS 1.2.13 WORKMANSHIP, COLORS, TEXTURES & FINISHES TO ESTABLISH STDS.
- FOR WORK. 1.3 SUBMITTALS DIRECT FROM SUBCONTRACTORS WILL BE RETURNED w/o
- ACTION THIS MEANS THEY WILL NOT BE REVIEWED OR APPROVED.
- 1.4 CONTRACTOR APPROVAL REPRESENTS DETERMINATION OF FIELD MEASUREMENTS, FIELD CONSTRUCTION CRITERIA, MATERIALS, CATALOG DATA & NO.s, AND CHECKING & COORDINATION w/ CONTRACT DOCUMENTS.
- 1.5 A/E REVIEWS FOR CONFORMANCE w/ DESIGN CONCEPT AND NOT ASSEMBLY IN WHICH THE ITEM(S) FUNCTION(S). REVIEW DOES NOT RELIEVE CONTRACTOR OF CONTRACT COMPLIANCE RESPONSIBILITY.
- 1.6 A/E NOTATIONS DO NOT IMPLY EITHER A REQUEST FOR OR APPROVAL TO CHANGE THE CONTRACT.
- 1.7 SUBMIT ELECTRONIC, ONE OF WHICH WILL BE RETAINED BY THE A/E. REVIEWED COPIES WILL BE RETURNED TO THE CONTRACTOR. ADDITIONAL COPIES SHALL BE MADE FROM THE RETURNED COPY.
- 1.8 MAINTAIN ONE SET OF REVIEWED SHOP DRAWINGS IN SITE AT ALL TIMES.
- 1.9 CONTRACTOR TO MARK AND IDENTIFY MATERIAL AND FINISHES COLOR SELECTION ON
- SUBMITTALS. UN-MARKED SUBMITTAL WILL NOT BE REVIEWED AND WILL BE RETURNED TO GC FOR CORRECTION

SECTION 014000 QUALITY CONTROL & TESTING LABORATORY SERVICES

- 1.1 INCLUDE INSPECTIONS, TESTS & RELATED ACTION BY INDEPENDENT AGENCIES GOVERNING AUTHORITIES, AS WELL AS DIRECTLY BY THE CONTRACTOR.
- 1.2 ACTIONS OF THIS SECTION & CONTRACT DOCUMENTS ARE NOT INTENDED TO LIMIT CONTRACTOR'S QUALITY CONTROL PROCEDURES, WHICH FACILITATE COMPLIANCE w/ THE CONTRACT DOCUMENTS.
- 1.3 THE CONTRACTOR SHALL EMPLOY & PAY FOR SERVICES OF INDEPENDENT TESTING LAB(S) TO PERFORM SPECIFIED SAMPLING & TESTING SERVICES:
- 1.3.1 THOSE REQUIRED BY LAW, ORDINANCE, REGULATIONS & ORDERS OF PUBLIC AGENCIES, & THE CONTRACT DOCUMENTS.
 - 1.3.2 CERTIFICATION OF PRODUCTS & MILL TEST REPORTS
 - 1.3.3 TEST, ADJUST & BALANCE OF EQUIPMENT.
 - 1.3.4 INSPECT, SAMPLE & TEST CONCRETE
- 1.4 FAILED RETESTS ARE AT THE CONTRACTOR'S EXPENSE
- 1.5 COOPERATE w/ INDEPENDENT AGENCIES PERFORMING REQUIRED TEST & PROVIDE REASONABLE ACCESS TO WORK & ASSISTANCE IN TAKING SAMPLES, DELIVERY TO TEST LABS & SECURITY & PROTECTION OF SAMPLES AT
- 1.6 SPECIFIC SAMPLING & TESTING AS REQUIRED PER SPECIFIC TRADE INSTALLATION AS HANDLED BY THE OWNER.
- 1.7 SUBMIT 3 COPIES OF REPORT OF CERTIFICATE OF CALIBRATION & REPORT OF INSPECTION OF FACILITIES MADE BY MATERIAL REFERENCE LABORATORY OF NATIONAL BUREAU OF STANDARDS, w/ EMO OF REMEDIES REPORTED BY INSPECTION., WHEN REQUIRED.
- 1.8 INCLUDE THE FOLLOWING ON SUBMITTED REPORTS:
 - 1.8.1 DATE ISSUED/DATE OF SAMPLING/DATE OF TEST
 - 1.8.2 PROJECT NAME & NUMBER
 - 1.8.3 TESTING LAB NAME & ADDRESS
 - 1.8.4 NAME & SIGNATURE OF INSPECTOR 1.8.5 RECORD OF TEMPERATURE & WEATHER
 - 1.8.6 I.D. OF PRODUCT AND SPECIFICATION
 - 1.8.7 LOCATION WITHIN THE PROJECT 1.8.8 TYPE OF INSPECTION OR TEST

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1.8.9 OBSERVATIONS REGARDING COMPLIANCE w/ CONTRACT DOCUMENTS

SECTION 016000 PRODUCTS

- 1.1 DO NOT ASSUME MATERIAL, EQUIPMENT OR METHODS WILL BE APPROVED AS EQUIVALENT UNLESS A/E EXPRESSLY ACCEPTED IN WRITING DURING BIDDING.
- PRINTED DIRECTIONS. 1.3 THE OWNER AND THE OCCUPANTS OF THE ADJACENT BUILDING ARE NOT RESPONSIBLE FOR DELIVERIES RELATED TO THE CONSTRUCTION CONTRACT;
- THEY CAN NOT SIGN FOR CONTRACTOR DELIVERIES. 1.4 CONTRACTOR SHALL TAKE SUFFICIENT MEASURES TO PROTECT
- CONSTRUCTION UNTIL SUBSTANTIAL COMPLETION. CONTRACTOR IS RESPONSIBLE FOR ALL MATERIAL STORED AND INSTALLED.

1.2 INSTALL PRODUCTS, EQUIPMENT, & SYSTEMS IN ACCORDANCE w/ MFR'S

1.5 THE OWNER'S WARRANTY PERIOD STARTS WITH THE ISSUANCE OF THE CERTIFICATE OF SUBSTANTIAL COMPLETION.

SECTION 017000 PROJECT CLOSEOUT

- 1.1 SUBMIT SPECIFIC WARRANTIES/WORKMANSHIP/MAINTENANCE BONDS MAINTENANCE AGREEMENTS, & FINAL CERTIFICATIONS AS REQUESTED.
- 1.2 OBTAIN & SUBMIT USE & OCCUPANCY PERMIT FOR FULL & UNRESTRICTED USE
- 1.3 PROVIDE PUNCH LIST OF INCOMPLETE ITEMS TO A/E PRIOR TO PROJECT
- 1.4 SUBMIT MARKED-UP DRAWINGS INDICATING INSTALLER'S DEVIATIONS FROM CONTRACT DOCUMENTS. EACH DRAWING SHALL BE LABELED 'PROJECT RECORD DRAWING', DATED AND SIGNED BY THE CONTRACTOR.
- 1.5 CONTRACTOR SHALL CERTIFY IN WRITING AND:
 - 1.5.1 A CERTIFICATION OF CODE COMPLIANCE 1.5.2 A CERTIFICATION THAT NO ASBESTOS CONTAINING MATERIAL WAS INCORPORATED INTO THE WORK. OF CODE COMPLIANCE 1.5.3 A CERTIFICATION THAT THE PROJECT RECORD DRAWINGS SHOW COMPLETE & ACCURATE AS-BUILT CONDITIONS INCLUDING w/OUT. LIMITATION, SIZES, KINDS OF MATERIALS, VITAL PIPING & VALVES, CONDUIT
- LOCATIONS & OTHER SIMILARLY REQUIRED ITEMS. 1.6 CONTRACTOR SHALL INSTRUCT THE OWNER'S PERSONNEL IN THE PROPER USE, CARE AND MAINTENANCE, & EMERGENCY REPAIR OF HVAC & ELECTRICAL.

SECTION 017100 CONSTRUCTION CLEANING

- 1.1 PROVIDE AND MAINTAIN DUMPSTER AT THE SPECIFIED LOCATION AS COORDINATED WITH OWNER.
- 1.2 REMOVE RUBBISH AND DEBRIS DAILY; BROOM CLEAN THE SITE WEEKLY.
 - 1.2.1 WET DRY MATERIALS TO PREVENT BLOWING DUST DAILY
 - 1.2.2 REMOVE MUD, DIRT AND FOREIGN MATERIALS FROM PUBLIC VIEW.
 - 1.2.3 BROOM CLEAN PUBLICLY VISIBLE CONSTRUCTION AREAS.
- 1.3 FINAL CLEANING
 - 1.3.1 REMOVE LABELS EXCEPT FOR HVAC/ ELEC. NAMEPLATE INFORMATION
 - 1.3.2 POLISH GLASS, LIGHT FIXTURES, LAMPS AND TRANSPARENT SURFACES.
 - 1.3.3 CLEAN DUST, DIRT, FILM, & DELETERIOUS STUFF FROM ALL SURFACES.
 - 1.3.4 MOP AND CLEAN ALL FLOOR SURFACES
 - 1.3.5 SANITIZE PLUMBING
 - 1.3.6 REMOVE STAINS FROM ALL SURFACES
 - 1.3.7 REPAIR DAMAGED AND COATED AREAS
 - 1.3.8 REMOVE AND REPLACE ALL HVAC FILTERS PRIOR TO FINAL INSPECTION.

SECTION 021000 SITE PREPARATION & SELECTIVE DEMOLITION

- 1.1 PROVIDE AND INSTALL ALL MATERIALS INCLUDING PAYING ALL FEES, LICENSES, TAXES, ETC.AS NECESSARY FOR THE ECXECUTION, INSTALLATION AND COMPLETION OF THE FOLLOWING:
 - 1.1.1 DISPOSE DEBRIS AND SURPLUS ACCORDING TO THE JURISDICTIONAL **AUTHORITIES**
 - 1.1.2 COMPLY WITH APPLICABLE AIR. DUST & WATER POLLUTION CONTROL
 - 1.1.3 PROCURE PERMITS TO TRANSPORT SOLID, LIQUID OR PARTICULATE
 - MATERIAL OFFSITE.
 - 1.1.4 POST ALL REQUIRED SIGNAGE, PERMITS, AND NOTICES. 1.1.5 PERIMETER EROSION & DUST CONTROL AS APPLICABLE.
 - 1.1.6 PREVENT MUD & DIRT FROM ENTERING BUILDING AND ENTRANCE WALKWAY.
- 1.2 MAINTAIN REQUIRED VEHICLE AND PEDESTRIAN ACCESS TO BUILDING AT ALL TIMES. THE EXISTING BUILDING MAY REMAIN IN OPERATION DURING THE DURATION OF THE CONSTRUCTION PERIOD. COORDINATE USE AND ACCESS WITH OWNER.
- 1.3 COORDINATE COMPACTION & STOCKPILING OF MATERIALS W/ CIVIL ENGINEER & JURISDICTIONAL AUTHORITIES AS APPLICABLE.
- 1.4 PREPARE, EXECUTE AND FILE EPA, NOI AND NOT WITH THE JURISDICATIONAL AUTHORITIES AS APPLICABLE.

SECTION 042000 BLOCK MASONRY - SEE ALSO STRUC.

- CONCRETE MASONRY UNIT (CMU): STANDARD C90 (NON-COLORED)
- MORTAR: SEE STRUCTURAL FOR TYPE.
- 1.2.1 COLOR: GREY 1.2 PERFORMANCE REQUIREMENT: COMPLY WITH ASTM C-90. PROVIDE CMU WITHFIRE-RESISTANT RATING IN COMPLIANCE WITH ASTM E-119. SEE STRUC.
- FOR ADDITONAL SPEC 1.3 MORTAR: COMPLYING WITH ASTM C-270, ; NON-FADING TYPE
- 1.4 GROUT: COMPLYING WITH ASTM C-476 (FOR TYPE AND PROPORTION OR GROUT INGREDIENTS) AND ASTM C-1019 (FOR COMPRESSIVE STRENGTH).
- WATER-PROOFING ADMIXTURE: NON-CHLORIDE, NON-CORROSIVE WATER-PROOFING ADMIXTURE COMPLYING WITH ASTM C494/C494M, TYPE C AND RECOMMENDED BY CMU MANUFACTURER
- WATER-REPELLENT ADMIXTURE: LIQUID WATER-REPELLENT MORTAR ADMIXTURE INTENDED FOR USE WITH CONCRETE MASONRY UNITS, CONTAINING INTEGRAL WATER REPELLENT BY SAME MANUFACTURER WATER: POTABLE
- REINFORCING BARS: DEFORMED STEEL, ASTM A615, GRADE 60, SEE STRUC.

1.9 INTERSECTING WALL ANCHOR:

- a. Z-TYPE RIGID STEEL BAR $\frac{1}{4}$ "X1"X24" WITH 3" I.D. BENDS. HOT-DIP FABRICATION. INSTALL IN ALTERNATE COURSES WITH HORIZONTAL WALL REINFORCING. BLOCK CORES IN TO WHICH THE TIES ARE PLACED SHALL
- BE FILLED WITH GROUT. b. PREFABRICATED CORNER AND TEE LADDER REINFORCEMENT, ASTM
- 1.10 PREMOLDED CONTROL JOINT STRIPS: SOLID RUBBER STRIPS WITH A SHORE A DUROMETER HARDNESS OF 60 TO 80, DESIGNED TO FIT STANDARD SASH BLOCK AND MAINTAIN LATERAL STABILITY IN MASONRY WALL, SIZE AND CONFIGURATION AS INDICATED. MATCH COLOR TO ADJACENT CMU.
- 1.11 COURSING: ONE CONCRETE MASONRY UNIT PLUS ONE JOINT SHALL EQUAL 8".
- ALL JOINTS SHALL BE $\frac{3}{8}$ " U.N.O. PATTERN BOND SHALL BE RUNNING BOND U.N.O. 1.12 MASONRY CLEANER - PROPRIETARY ACIDIC CLEANER: MANUFACTURERS STANDARD-STRENGTH CLEANER DESIGNED FOR REMOVING MORTAR/GROUT STAINS, EFFLORESCENCE, AND OTHER NEW CONSTRUCTION STAINS FROM NEW MASONRY WITHOUT DISCOLORING OR DAMAGING MASONRY SURFACE.
- 1.13 SINGLE SINGLE WYTHE WALL UNIT DRAINAGE SYSTEM
- 1. DESCRIPTION: UNIT PAN DRAINAGE SYSTEM SHALL BE MANUFACTURED ASSEMBLED THAT CONSISTS OF THE FOLLOWING COMPONENTS:
- a. PAN IS A HIGH DENSITY POLYPROPYLENE COMPOSITION .0625 INCH THICK (1.59 MM) WITH (7.94) PERIMETER FLANGE, WITH A WEEP SPOUT OPENING AND A 45 DEGREES DRIP EDGE THAT EXTENDS 1.0 INCHES (25.4 MM) FROM THE OUTER FLANGE. WIDTH SHALL BE 8 INCHES.
- b. INTEGRATED WEB SPACER/BRIDGE UNIT IS A HIGH DENSITY POLYPROPYLENE .0625 INCH THICK (1.59 MM) THAT OVERLAPPED THE ADJACENT PAN AND EXTENDS FROM FACE SHELL TO FACE SHELL. BRIDGE IS REMOVABLE FOR CORNER INSTALLATION.
- c. DRAINAGE MATTES & BUG GUARDS ARE AN OPEN WEAVE POLYESTER MESH (7X16 INCH) INSTALLED IN EACH CMU CELL ABOVE THE PAN.
- 2. SUBJECT TO COMPLIANCE WITH REQUIREMENTS, PRODUCTS THAT MAY BE INCORPORATED INTO THE WORK INCLUDE, BUT ARE NOT LIMITED TO, THE
- a. BLOK-FLASH AS MANUFACTURED BY MORTAR NET (BASIS-OF-DESIGN) b. CAVITY-WEEP AS MANUFACTURED BY MASONRY TECHNOLOGIES c. CAVITY-VENT AS MANUFACTURED BY HECKMANN BUILDING PRODUCTS, INC. OR AN APPROVED EQUAL.

1.14 MASONRY-CELL INSULATION: FOAM-IN-PLACE INSULATION

- 1. MATERIAL: MULTI-COMPONENTS THERMAL INSULATIN PRODUCED BY COMBINING PLASTIC RESIN
- AND CATALYST FOAMING AGENT SURFACTANT WHICH WHEN PROPERLY RATIOED AND MIXED
- TOGETHER WITH COMPRESSED AIR PRODUCE A COLD-SETTING FOAM INSULATION IN THE HOLLOW
- CORES OF HOLLOW UNIT MASONRY WALL.
- a. COMPLY WITH ASTM E-84 NON-COMBUSTIBLE
- c. R VALUE OF 4 PER INCH MIN. PER ASTM C-177
- 2. SUBJECT TO COMPLIANCE WITH REQUIREMENTS, PRODUCTS THAT MAY BE INCORPORATED INTO THE WORK INCLUDE, BUT ARE NOT LIMITED TO, THE
- a. CORE-FILL 500 AS MANUFACTURED BY TAILORED CHEMICAL PRODUCTS,
- (BASIS-OF-DESIGN) b. THERMCO AS MANUFACTURED BY THERMAL CORPORATION OF AMERICA
- c. POLYMASTER R-501 AS MANUFACTURED BY POLYMSTER, INC.
- d. OR AN APPROVED EQUAL.

SECTION 055000 METAL FABRICATIONS

- 1.1 PERFORMANCE REQUIREMENTS:
 - 1. WELDING: QUALIFY PROCEDURES AND PERSONNEL ACCORDING TO THE
 - **FOLLOWING:** a. AWS D1.1, "STRUCTURAL WELDING CODE--STEEL."
 - b. AWS D1.2, "STRUCTURAL WELDING CODE--ALUMINUM."
 - c. AWS D1.3, "STRUCTURAL WELDING CODE--SHEET STEEL d. AWS D1.6, "STRUCTURAL WELDING CODE--STAINLESS STEEL."
- 1.2 MATERIALS: A. ALUMINUM-ALLOY ROLLED TREAD PLATE: ASTM B 632/B 632M, ALLOY 6061-T6.
 - B. ALUMINUM CASTINGS: ASTM B 26/B 26M, ALLOY 443.0-F.
 - C. STEEL PLATES, SHAPES, AND BARS: ASTM A 36/A 36M. D. STAINLESS-STEEL SHEET, STRIP, PLATE, AND FLAT BARS: ASTM A 666, TYPE 304.
- E. STAINLESS-STEEL BARS AND SHAPES: ASTM A 276, TYPE 304. 1.3 FASTENERS: STAINLESS STEEL OR HOT-DIPPED ZINC COATED GALVANIZED STEEL
- A. MATERIAL/FINISH: HOT-DIPPED GALVANIZED STEEL, SHOP PRIMED FOR FIELD
- B. DESCRIPTION: INSECT SCREEN WIRE MESH ASSEMBLY PRODUCT FOR INSECT SCREEN AT CMU WALL. THE ASSEMBLY SHALL BE MANUFACTURED ASSEMBLED
 - THAT CONSISTS OF THE FOLLOWING COMPONENTS: a. 16 GAGE RECTANGULAR $\frac{1}{2}$ " WIRE-MESH INSECT SCREEN, WELDED CONST.
 - b. 16 GAGE U-EDGING TO PROVIDE FRAMING, PROVIDE PRE-DRILLED HOLES AT 12" OC, SIZE HOLES TO FIT FASTENERS.

c. 1 INCHES BY 1½ INCHES MOUNTING ANGLE WITH PRE-DRILLED HOLES,

- EACH SIDE, SIZE HOLES TO FIT FASTENERS.
- FASTENERS: MANUFACTURED STANDARD, HOT-DIPPED GALV. 2. SUBJECT TO COMPLIANCE WITH REQUIREMENTS, PRODUCTS THAT MAY BE INCORPORATED INTO THE WORK INCLUDE, BUT ARE NOT LIMITED TO, THE
- **FOLLOWING MANUFACTURERS:** a. MCNICHOLS (BASIS-OF-DESIGN)
- b. BROWN-CAMPBELL

LOCATE 2 PER

- MECHANICAL METALS
- d. OR AN APPROVED EQUAL.

SECTION 07 46 00 - MINERAL FIBER CEMENT BOARD

- A. PROVIDE ALL OF THE LABOR, MATERIALS, EQUIPMENT, AND SERVICES REQUIRED TO FURNISH AND INSTALL THE SOFFIT WITH MOULDING AND ACCESSORIES WHERE SHOWN ON DRAWINGS OR AS SPECIFIED HEREIN.

SECTION 07 46 00 - MINERAL FIBER CEMENT BOARD (CONT.)

SUBMITTAL

- A. PRODUCT DATA: MANUFACTURER'S DATA SHEETS ON EACH PRODUCT TO BE USED, INCLUDING:
- 1. INSTALLATION INSTRUCTIONS AND RECOMMENDATIONS.
- STORAGE AND HANDLING REQUIREMENTS AND RECOMMENDATIONS.
- 3. MANUFACTURER'S BEST PRACTICE GUIDE
- 4. TECHNICAL DATA SHEET.

1.3 WARRANTY

A. SPECIAL WARRANTY: MANUFACTURER'S STANDARD FORM IN WHICH MANUFACTURER AGREES TO REPAIR OR REPLACE SIDING THAT DOES NOT COMPLY WITH REQUIREMENTS OR THAT FAILS WITHIN SPECIFIED WARRANTY PERIOD. FAILURES INCLUDE, BUT ARE NOT LIMITED TO CRACKING, DEFORMING, FADING, OR OTHERWISE DETERIORATING BEYOND NORMAL WEATHERING.

2.1 MANUFACTURER

- B. IN OTHER PART 2 ARTICLES WHERE TITLES BELOW INTRODUCE LISTS, THE FOLLOWING REQUIREMENTS APPLY TO PRODUCT SELECTION:
- MANUFACTURERS: SUBJECT TO COMPLIANCE WITH REQUIREMENTS, PROVIDE PRODUCTS BY ONE OF THE MANUFACTURERS SPECIFIED. ACCEPTABLE PRODUCT SHALL BE A COMPARABLE PRODUCT WITH THE BASIS-OF-DESIGN PRODUCT.
- a. JAMES HARDIE INC. (BASIS-OF-DESIGN).
- b. CERTAINTEED CORPORATION.
- c. NICHIHA

B. PERFORMANCE REQUIREMENTS:

- FIBER-CEMENT SIDING, COMPLIES WITH ÅSTM C 1186 TYPE A GRADE II AS PANEL BOARD, TRIM BOARD, SOFFIT AND SIDING MADE FROM FIBER-CEMENT BOARD THAT DOES NOT CONTAIN ASBESTOS.
- 2. FIBER-CEMENT SIDING, COMPLIES WITH ASTM E 136 AS A NONCOMBUSTIBLE MATERIAL.
- 3. FIBER-CEMENT SIDING, COMPLIES WITH ASTM E 84 CLASS A
- a. FLAME SPREAD INDEX = 0 25 b. SMOKE DEVELOPED INDEX = 0 - 450
- 4. FIBER-CEMENT SIDING, COMPLIES WITH ASTM E 119 1 HOUR AND 2 HOUR FIRE RESISTIVE ASSEMBLIES.
- 5. FIBER-CEMENT SIDING, TESTED TO ASTM E330 FOR TRANSVERSE 6. SIDING TO MEET THE FOLLOWING BUILDING CODE COMPLIANCE
- NATIONAL EVALUATION REPORT ICC-ER FOR THE FOLLOWING PROPERTIES:
- a. WEATHER RESISTANCE
- b. STRUCTURAL (TRANVERSE LOADING) c. SURFACE-BURNING CHARACTERISTICS
- d. FIRE-RESISTANCE RATED CONSTRUCTION

2.2 SOFFIT

- A. PRODUCT
- 1. HARDIESOFFIT® PANEL 2. TEXTURE: VENTED AS INDICATED IN DRAWINGS. VENTED PANEL SHALL HAVE NOT LESS THAN 5 S.IN OF NET FREE VENTILATION PER LINEAR
- 3. THICKNESS: 1/4 INCH THICK

RECOMMENDATION

PENETRATE 1" INTO STUDS.

4. SIZE: 24" WIDE 5. FINISH: SMOOTH, FIELD PAINTED, FOLLOW MANUFACTURER

2.3 FASTENERS

A. WOOD FRAMING: 6D GALVANIZED SIDING NAILS (MIN. 0.093" SHANK X 0.222" HEAD CORROSION RESISTANT SIDING NAILS). MUST BE OF LENGTH TO

SECTION 079000 JOINT SEALANT

1.1 DESCRIPTION CONTINUED: A. MULTI-COMPONENT POLYURETHANE SEALANT, MILDEW RESISTANT, NON-SAG, LOW-MODULUS WITH +25% JOINT MOVEMENTS ALLOWANCE THAT CAN WITHSTAND CONSTANT WATER IMMERSION. PRODUCT MUST BE SUITABLE FOR VARIOUS SUBSTRATE INCLUDING CONCRETE, STEEL, CMU AND TREATED

WOOD.

- 1.2 PERFORMANCE REQUIEREMENTS: A. ASTM C920, TYPE M, GRADE NS, CLASS 25, USE NT/G/M/A
- B. ASTM C1247 FOR WATER IMMERSION APPLICATION
- C. FEDERAL INSPECTION TT-S-00227E TYPE II, CLASS A D. ASTM D412 FOR TENSILE STRENGTH
- E. ASTM C661 FOR HARDNESS, SHORE A (25 MIN.) F. ASTM C719 BOND DURABILITY TO GLASS, ALUMINUM AND CONCRETE G. ASTM C794 FOR ADHESION IN PEEL 1.3 SUBJECT TO COMPLIANCE WITH REQUIREMENTS, PRODUCTS THAT MAY BE

INCORPORATED INTO THE WORK INCLUDE, BUT ARE NOT LIMITED TO, THE

- FOLLOWING MANUFACTURERS: 1. BASF
- 2. POLYMERIC SYSTEM INC. 3. PECORA

4. OR AN APPROVED EQUAL.


- **CONTINUED ON NEXT PAGE**

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SPECIFICATION 2

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PROJECT SPECIFICATIONS (continued)

- JOINT BACKING: ROUND CLOSED-CELL POLYETHYLENE.
- A. JOINT BACKING: CLOSED-CELL POLYETHYLENE, PROVIDE AT ALL JOINTS DEEPER THAN ½".
- B. WHERE JOINT DEPTH DOES NOT PERMIT USE OF JOINT BACKING, A **RELEASE PAPER OR BOND**
 - BREAKER SHALL BE USED.
- C. ON HORIZONTAL JOINTS. SURFACE MUST BE CLEANED AND PRIMED USING PRIMER AS RECOMMENDED BY THE SEALANT MANUFACTURER.

SECTION 07410 PREFORMED ALUMINUM SOFFIT PANELS

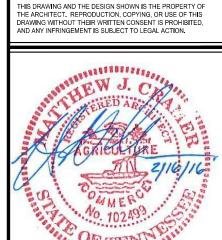1.1 DESCRIPTION OF WORK

- A. THIS SECTION COVERS THE PRE-FINISHED, PRE-FABRICATED FACTORY MANUFACTURED ALUMINUM SOFFIT SYSTEM. ALL METAL TRIM, ACCESSORIES, FASTENERS, INSULATION AND SEALANTS INDICATED ON THE DRAWINGS ARE PART OF THIS SECTION
- B. RELATED WORK SPECIFIED ELSEWHERE
- C. ROOF DECK STRUCTURAL STEEL. FLAT ROOF SYSTEMS. PREFORMED METAL STANDING SEAM ROOFING, PERIMETER EDGE SYSTEMS, ROOF HATCHES, FIRESTOPPING NOT INCLUDED IN THIS SECTION

1.2 QUALITY ASSURANCE

- A. BASIS OF DESIGN PETERSEN ALUMINUM CORP, ACWORTH, GA, 800-272-4482 PRODUCTS ESTABLISH A MINIMUM OF QUALITY REQUIRED.
- B. MANUFACTURER AND ERECTOR SHALL DEMONSTRATE EXPERIENCE OF A MINIMUM OF FIVE (5) YEARS IN THIS TYPE OF PROJECT

1.3 SUBSTITUTIONS

A. THE MATERIAL, PRODUCTS AND EQUIPMENT SPECIFIED IN THIS SECTION ESTABLISH A STANDARD FOR REQUIRED FUNCTION, DIMENSION, APPEARANCE AND QUALITY TO BE MET BY ANY PROPOSED SUBSTITUTION.

1.4 SYSTEM DESCRIPTION

- A. MATERIAL TO COMPLY WITH:
- 1. ASTM B209 STANDARD SPECIFICATION FOR ALUMINUM AND ALUMINUM-ALLOY SHEET AND PLATE

1.6 WARRANTIES

- A. FINISH WARRANTY: MANUFACTURER'S STANDARD FORM IN WHICH MANUFACTURER AGREES TO REPAIR FINISH OR REPLACE STANDING SEAM METAL ROOF PANELS THAT SHOW EVIDENCE OF DETERIORATION OF FACTORY-APPLIED FINISH WITHIN SPECIFIED WARRANTY PERIOD.
- 1. EXPOSED PANELS FINISH DETERIORATION INCLUDES THE FOLLOWING:
- a. COLOR FADING MORE THAN 5 HUNTER UNITS WHEN TESTED ACCORDING TO ASTM D 2244
- b. CHALKING IN EXCESS OF A NO. 8 RATING WHEN TESTED ACCORDING TO ASTM D 4214
- c. CRACKING, CHECKING, PEELING OR FAILURE OF A PAINT TO ADHERE TO
- 2. WARRANTY PERIOD: 20 YEARS FROM THE DATE OF SUBSTANTIAL

2.1 PANEL DESIGN

A. SOFFIT PANELS SHALL BE 12" WIDE BY 3/8" DEEP AND MANUFACTURER SHALL BE ABLE TO PROVIDE SPECIFIED PANEL SURFACE: SOLID SOFFIT IN THE SPECIFIED COLOR. PROVIDE SINGLE INTERMEDIATE GROOVE.

2.2 ACCEPTABLE MANUFACTURERS

- A. THIS PROJECT IS SPECIFIED AROUND THE ROOFING PRODUCT OF PETERSEN ALUMINUM CORPORATION, PETERSEN ALUMINUM CORP, ACWORTH, GA, 800-272-4482, PAC-850 SOFFIT.
- B. OTHER ACCEPTABLE MANUFACTURERS. IF THEY COMPLY WITH SPECIFICATION:

2.3 MATERIALS AND FINISHES

- A. MATERIALS: ASTM B-209 QUALITY ALUMINUM, 3105-H14 ALLOY AND TEMPER MATERIAL. ALUMINUM SHALL BE TENSION LEVELED (TEMPER PASSED AND STRETCHER LEVELED) WITH CAMBER OF A MAXIMUM OF 1/4" IN 20 FEET, MANUFACTURED IN THE USA, AND SHALL BE .032" THICK ALUMINUM, US STANDARD GRADE
- 1. COLOR SHALL BE PAC-CLAD KYNAR 500 BONE WHITE
- 2. PANEL SURFACE SHALL BE: SOLID
- B. FINISHES: FINISH SHALL BE KYNAR 500 OR HYLAR 5000 FLUOROCARBON COATING WITH A TOP SIDE FILM THICKNESS OF 0.70 TO 0.90 MIL OVER 0.25 TO 0.31 MIL PRIME COAT TO PROVIDE A TOTAL DRY FILM THICKNESS OF 0.95 TO 1.25 MIL. FINISH SHALL CONFORM TO TESTS FOR ADHESION, FLEXIBILITY AND LONGEVITY AS SPECIFIED BY KYNAR 500 OR HYLAR 5000 FINISH SUPPLIER.
- C. TRIM: TRIM SHALL BE FABRICATED OF THE SAME MATERIAL AND FINISH TO MATCH THE PROFILED SHEETING AND PRESS BROKEN IN LENGTHS OF 10 - 12 FEET. TRIM SHALL BE FORMED ONLY BY THE MANUFACTURER OR THEIR APPROVED DEALER. TRIM TO BE ERECTED IN OVERLAPPED CONDITION. USE LAP STRIPS ONLY AS INDICATED ON DRAWINGS. MITER CONDITIONS SHALL BE FACTORY WELDED MATERIAL TO MATCH THE SHEETING.
- C. FASTENERS: FASTENERS SHALL BE 400 SERIES STAINLESS STEEL, DISHED WASHERS STAINLESS STEEL WITH BONDED NEOPRENE.
- D. ZEES: WHERE REQUIRED BY DESIGN OF PRIMARY STRUCTURAL FRAMING SYSTEM, ZEES SHALL BE USED TO SPAN BETWEEN BEAMS AND/OR OTHER JOISTS, THERMALLY RESPONSIVE BASE AND TOP CLIPS SHALL BE FASTENED. TO THE ZEES ON 12" CENTERS.
- E. INSULATION: SEE SECTION 07210: BUILDING INSULATION

SECTION 07410 PREFORMED ALUMINUM SOFFIT PANEL (cont.)

2.3 MATERIALS AND FINISHES (CONTINUED)

- TRIM: TRIM SHALL BE FABRICATED OF THE SAME MATERIAL AND FINISH TO MATCH THE PROFILED SHEETING AND PRESS BROKEN IN LENGTHS OF 10 - 12 FEET. TRIM SHALL BE FORMED ONLY BY THE MANUFACTURER OR THEIR APPROVED DEALER. TRIM TO BE ERECTED IN OVERLAPPED CONDITION. USE LAP STRIPS ONLY AS INDICATED ON DRAWINGS. MITER CONDITIONS SHALL BE FACTORY WELDED MATERIAL TO MATCH THE SHEETING.
- FASTENERS: FASTENERS SHALL BE 400 SERIES STAINLESS STEEL, DISHED WASHERS STAINLESS STEEL WITH BONDED NEOPRENE
- ZEES: WHERE REQUIRED BY DESIGN OF PRIMARY STRUCTURAL FRAMING SYSTEM, ZEES SHALL BE USED TO SPAN BETWEEN BEAMS AND/OR OTHER JOISTS. THERMALLY RESPONSIVE BASE AND TOP CLIPS SHALL BE FASTENED TO THE ZEES ON 12" CENTERS.
- INSULATION: SEE SECTION 07210: BUILDING INSULATION.

2.4 SEALANTS

- A. PROVIDE TWO-PART POLYSULFIDE CLASS B NON-SAG TYPE FOR VERTICAL AND HORIZONTAL JOINTS OR -
- ONE PART POLYSULFIDE NOT CONTAINING PITCH OR PHENOLIC EXTENDERS
- C. EXTERIOR GRADE SILICONE SEALANT RECOMMENDED BY ROOFING MANUFACTURER OR -
- ONE PART NON-SAG, GUN GRADE EXTERIOR TYPE POLYURETHANE RECOMMENDED BY THE ROOFING MANUFACTURER.

SECTION 081100 HOLLOW METAL DOORS

- GENERAL: NFCR 100-91 AS QUALITY STANDARD, FULLY WELDED.
- 1.2 DOOR CORE CONSTRUCTION: U-VALUE OF .350 OR LESS, PROVIDE
- POLYURETHANE INSULATION
- DOOR AND FRAME: 16 GAUGE, SDI LEVEL 3 "EXTRA HEAVY-DUTY", MODEL 2A
- "SEAMLESS", FIELD PAINTED TO MATCH EXISTING. 1.4 FRAME ANCHORS: 3-JAMB WIRES AND FLOOR ANCHORS, HOT-DIPPED GALV.
- HARDWARE PREPARATION PER ANSI/SDI A-250 AND A115 STANDARD,
- COORDINATE WITH HARDWARE SCHEDULE.
- 1.6 SHOP PRIME, FIELD FINISH 2 COATS.

SECTION 087100 DOOR HARDWARE

- 1.1 MINIMUM GAUGE: 7 GAUGE (HING REINFORCEMENTS); 12 GAUGE (UNIVERSAL STRIKE REINFORCEMENTS)
- 1.2 PROVIDE 3 COPIES OF EACH KEY. FINAL KEYING BY OWNER. PROVIDE "BEST" EXTRA HEAVY DUTY CORE, COORDINATE WITH OWNER.
- NO SPECIFIC MANUFACTURER, KEY TO MASTER ADJACENT EXISTING BUILDINGS. PROVIDE HEAVY DUTY HARDWARE BY SCHALGE OR APPROVED EQUAL.
- COORDINATE HARDWARE, LOCKSETS, KEYING, ETC. W/ OWNER PRIOR TO PROJECT COMPLETION.
- 1.5 ALL NEW DOOR HARDWARE SHALL BE ADA COMPLIANT.

SECTION 099100 PAINT - POLYESTER-EPOXY AND OIL-BASE WATER-PROOF TYPE.

1.1 CONCRETE BLOCK:

- 1. SURFACE PREPARATION: SSPC-SP13/NACE 6
- 2. PRIMER: INDUSTRIAL & MARINE. KEM CATI-COAT HS EPOXY FILLER/SEALER. B24W400/V400 S
- 3. MID-COAT: INDUSTRIAL & MARINE SHERWIN WILLIAMS DURAPLATE 235 4. TOP-COAT: SHERWIN WILLIAMS DTM SEMI-GLOSS.
- SUBJECT TO COMPLIANCE WITH REQUIREMENTS, PRODUCTS THAT MAY BE INCORPORATED INTO THE WORK INCLUDE, BUT ARE NOT LIMITED TO, THE **FOLLOWING MANUFACTURERS:**
- 1. SHERWIN WILLIAMS (BASIS-OF-DESIGN)
- 2. PORTER PAINT
- 3. ICI DULUX

SECTION 10520 FIRE EXTINGUISHER

1.1 TYPE: 4A-60B:C WITH MANUFAC. STANDARD WALL BRACKET, SHALL COMPLY WITH NFPA 10 AND LABELED BY FMG.

SECTION 096100 CONCRETE SEALER

- 1.1 DESCRIPTION: SILICATE BLEND. SHALL BE A CLEAR PENETRATING WATER-BASED SEALER FOR DENSIFYING AND DUSTPROOFING.
- 1.2 SUBJECT TO COMPLIANCE WITH REQUIREMENTS, PRODUCTS THAT MAY BE INCORPORATED INTO THE WORK INCLUDE, BUT ARE NOT LIMITED TO, THE **FOLLOWING:**
- 1. CT DENSIFYER AS MANUFACTURED BY CHEMPROBE (BASIS-OF-DESIGN)
- 2. FX-424 AS MANUFACTURED BY FOX INDUSTRIES
- 3. H & C 4. OR AN APPROVED EQUAL.

101750 TOILET COMPARTMENTS AND URINAL SCREENS

- 1. TOILET PARTITIONING: FLOOR-MOUNTED, HEADRAIL-BRACED.
- 2. URINAL SCREENS: WALL MOUNTED, FLOOR SUPPORTED
- 2. DESCRIPTION: PROVIDE PANELS, PILASTERS, AND DOORS CONSTRUCTED OF HIGH DENSITY POLYETHYLENE (HDPE) MATERIAL WITH CONTINUOUS ALUMINUM EDGING STRIPS ON THE BOTTOMS OF ALL PANELS AND FULL LENGTH WALL BRACKETS. MATERIAL SHALL BE IN COMPLIANCE WITH ASTM E-84.
- 3. WARRANTY: 15-YEARS LIMITED WARRANTY AGAINST FACTORY DEFECTS FOR PANELS AND 1-YEARS WARRANTY AGAINST MATERIAL AND WORKMANSHIP DEFECTS FOR STAINLESS STEEL HARDWARES
- B. HEADRAIL: PROVIDE INTEGRAL ANTI-GRIP, LOAFER RAIL, EXTRUDED ALUMINUM HEAT-TREATED AND ANODIZED WITH NECESSARY FITTINGS.
- C. HARDWARE AND FITTINGS (ALL STAINLESS STEEL)

 - WALL BRACKET: CONTINUOUS 54" MIN.
 - 2. FASTENERS, SHOE/BASE COVER, CONTINUOUS PARTITION BRACKETS (FULL PARTITION HEIGHT) AND HEADRAIL MOUNTING BRACKETS: MOUNT TO SUBSTRATE WITH TAMPER-PROOF TOGGLE BOLTS.
 - 3. DOOR HINGES: PROVIDE 8" "HANDICAP" HINGE AT ALL DOORS. MOUNT TO PILASTERS WITH TAMPER-PROOF THRU-BOLTS. HINGES SHALL BE HEAVY DUTY TYPE AND CAPABLE OF WITHSTANDING 250 LBS. OF PRESSURE FROM ANY
 - 4. DOOR LATCH/STRIKE SET: FASTENED WITH TAMPER-PROOF FASTENERS 5. DOOR COAT HOOK/BUMPER: CHROME-PLATED ZINC ALLOY DIE CASTING EQUIPPED WITH RUBBER BUMPER ON END OF HOOK, FASTENED WITH
 - NON-REVERSING TAMPER-PROOF SCREWS. 6. DOOR PULL: CHROME-PLATED ZINC ALLOY DIE CASTING FASTENED WITH TAMPER-PROOF NON-REVERSING SCREWS.
- D. FINISHES: ARCHITECT TO SELECT FROM MANUFAC. STANDARD COLOR AND **TEXTURES**
- E. SUBJECT TO COMPLIANCE WITH REQUIREMENTS, PRODUCTS THAT MAY BE INCORPORATED INTO THE WORK INCLUDE, BUT ARE NOT LIMITED TO, THE
 - 1. SCRANTON PRODUCTS (BASIS-OF-DESIGN)
 - 2. BOBRICK
 - 3. GLOBAL PARTITIONS
- 4. OR AN APPROVED EQUAL

SECTION 102800 TOILET ACCESSORIES

- A. BASIS-OF-DESIGN PRODUCT: THE DESIGN FOR ACCESSORIES IS BASED ON PRODUCTS INDICATED. SUBJECT TO COMPLIANCE WITH REQUIREMENTS, PROVIDE THE NAMED PRODUCT OR A COMPARABLE PRODUCT BY ONE OF THE **FOLLOWING:**
- 1. AMERICAN SPECIALTIES, INC.
- 2. A & J WASHROOM ACCESSORIES, INC
- 3. BOBRICK WASHROOM EQUIPMENT, INC.
- 4. BRADLEY CORPORATION
- 5. OR APPROVED EQUAL WITH COMPATIBLE PRODUCT PERFORMANCE. B. TOILET TISSUE (ROLL) DISPENSER:
- BASIS-OF-DESIGN PRODUCT: AMERICAN SPECIALTIES, INC. MODEL 0264-1A
- 2. DESCRIPTION: DOUBLE-ROLL DISPENSER
- 3. MOUNTING: SURFACE MOUNTED.
- 4. OPERATION: CONTROLLED DELIVERY. TO BE IMPACT RESISTANT WITH "NO-WASTE" ROCKING ACTION SPINDLE, ABS THERMOPLASTIC AND BE THEFT RESISTANT WITH CONCEALED RELEASE MECHANISM. SPINDLE SHALL ROTATE 1/2 REVOLUTION FOR EACH OPERATION AND RETURN TO ITS ORIGINAL POSITION. ROLL CORE SHALL NOT BE REMOVABLE UNTIL TISSUE IS
- 5. CAPACITY: DESIGNED FOR ALL STANDARD CORE ROLL TISSUE UP TO 6 INCHES IN DIAMETER.
- 6. MATERIAL AND FINISH: CAST ALUMINUM WITH SATIN MATTE SILVER-GRAY

C. LIQUID-SOAP DISPENSER:

- BASIS-OF-DESIGN PRODUCT: AMERICAN SPECIALTIES, INC. MODEL 0345 2. DESCRIPTION: DESIGNED FOR DISPENSING SOAP IN LIQUID OR LOTION
- 3. MOUNTING: HORIZONTALLY ORIENTED, SURFACE MOUNTED.
- 4. CAPACITY: 40 OZ. (ML)
- 5. MATERIALS: 20 GAUGE STAINLESS STEEL, ALLOY 18-8, TYPE 304 WITH NO. 4 SATIN FINISH. VALVE OPERATION SHALL COMPLY WITH ADA GUIDELINES OF NO MORE THAT 5 LBS PRESSURE TO ACTUATE AND REQUIRE NO GRASPING OR TWISTING.
- 6. LOCKSET: TUMBLER TYPE WITH SPECIAL KEY.
- D. GRAB BAR:
 - 1. DIMENSIONS: $1\frac{1}{4}$ " TO $1\frac{1}{2}$ " IN WIDTH OR OUTSIDE DIAMETER, CLEAR HAND SPACE MUST BE 1 ½" BETWEEN THE INNER FACE OF THE GRAB BAR AND THE FINISHED FACE OF THE WALL/PARTITION.
 - 2. CAPACITY: GRAB BARS MUST BE ABLE TO SUPPORT A 250 LB LOAD APPLIED IN ANY DIRECTION ALONG ITS LENGTH.
 - 3. MOUNTING: FLANGES WITH CONCEALED FASTENERS.
 - 4. MATERIAL: STAINLESS STEEL, 0.05 INCH THICK, SMOOTH, NO. 4. SATIN FINISH.

E. MIRROR UNIT:

- 1. BASIS-OF-DESIGN PRODUCT: BOBRICK- MODEL B-165
- 2. DESCRIPTION: FRAMELESS STAINLESS STEEL MIRROR.
- 3. MATERIAL: ALLOY 18-8 STAINLESS STEEL TYPE 304, 20 GAUGE WITH NO. 8 MIRROR FINISH. BACKING SHALL BE 1/4 INCH THICK TEMPERED WATERPROOF MASONITE. UNIT SHALL HAVE 5/16 RETURNS TO WALL
- ALL AROUND. 4. HANGERS: PRODUCE RIGID, TAMPER- AND THEFT-RESISTANT INSTALLATION, USING METHOD INDICATED BELOW.
- a. ONE-PIECE. GALVANIZED STEEL. WALL-HANGER DEVICE WITH SPRING-ACTION LOCKING MECHANISM TO HOLD MIRROR UNIT IN POSITION WITH NO EXPOSED SCREWS OR BOLTS.
- b. WALL BRACKET OF GALVANIZED STEEL, EQUIPPED WITH CONCEALED LOCKING DEVICES REQUIRING A SPECIAL TOOL TO REMOVE.

SECTION 102800 TOILET ACCESSORIES (CONTINUED)

- BABY CHANGING STATION
 - 1. BASIS-OF-DESIGN PRODUCT: KOALA CORPORATION MODEL KB110-SSW, 18-GA STAINLESS STEEL TYPE 304.
 - 2. DESCRIPTION: BABY CHANGING STATION HORIZONTAL SUPPORTS STATIC LOADS UP TO 400 LBS. STEEL-ON-STEEL HINGES WITH 12 GAUGE STEEL MOUNTING SUPPORTS ADA COMPLIANT WITH PROPER INSTALLATION. CHILD PROTECTION STRAPS AND DIAPER BAG HOOK. MOLDED-IN LINER DISPENSER WILL HOLD APPROXIMATELY 25 SANITARY LINERS. FDA APPROVED BLOW-MOLDED HIGH-DENSITY POLYETHYLENE WITH MICROBAN ANTIMICROBIAL ADDITIVE (RESISTS ODORS AND BACTERIAL GROWTH). REINFORCED FULL-LENGTH STEEL-ON-STEEL HINGE MECHANISM, WITH 11-GAUGE STEEL MOUNTING PLATES AND MOUNTING HARDWARE INCLUDED. MOLDED-IN GRAPHICS AND SAFETY MESSAGES IN SIX LANGUAGES AND BRAILLE. CONTOURED CHANGING SURFACE AREA IS 442 SQ IN (2873 SQ MM). 3. MOUNTING: WALL MOUNTED
- G. WARM-AIR DRYER:
 - 1. BASIS-OF-DESIGN PRODUCT: EXCEL DRYER; XLERATOR SERIES; XL-C 2. DIMENSIONS: 11 3/4" LG BY 12 11/16" HIGH BY 6 11/16" DEEP
 - WEIGHT: 16 LBS.
 - 4. MOUNTING: SEMI-RECESSED WITH ADA MOUNTING KIT BOX
 - 5. OPERATION: INFRA-RED SENSOR ACTIVATED WITH TIMED POWER CUT-OFF a. OPERATION TIME: UNDER 35 SECONDS.
- DIE-CAST ZINC ALLOY, TO BE RUST-PROOF, CHIP-PROOFED AND TAMPER/VANDAL-PROOF ELECTRICAL REQUIREMENTS: 115 V, 14.4 A, 1653 W. 7. COLOR: STAINLESS STEEL

6. COVER MATERIAL AND FINISH: ONE-PIECE, HEAVY-DUTY, RIB-REINFORCED.

APPROVED EQUAL H. UNDER LAVATORY GUARD - PROVIDE ADA PIPE GUARD ON EXPOSED PLUMBING.

8. OTHER ACCEPTABLE MANUFACTURER: WARM AIR DRYER, ASI OR AN

SECTION 101400 SIGNAGE

- 1.1 PANEL SIGNS
 - A. EXTERIOR PANEL SIGNS: PROVIDE SMOOTH SIGN PANEL SURFACES CONSTRUCTED TO REMAIN FLAT UNDER INSTALLED CONDITIONS WITHIN A TOLERANCE OF PLUS OR MINUS 1/16 INCH (1.5 MM) MEASURED DIAGONALLY FROM CORNER TO CORNER, COMPLYING WITH THE FOLLOWING **REQUIREMENTS:**
 - 1. EDGE CONDITION: BULLNOSE.
 - 2. CORNER CONDITION: ROUNDED TO RADIUS INDICATED
 - 3. CUSTOM PAINT COLORS: MATCH PANTONE COLOR MATCHING SYSTEM. 4. COLOR: AS SELECTED BY ARCHITECT FROM MANUFACTURER'S FULL
 - 5. BASIS-OF-DESIGN: "GRAPHIC BLAST FG" AS MANUFACTURED BY BEST MANUFACTURING SIGN
 - SYSTEMS OR APPROVED EQUAL. a. DESCRIPTION: 1/8" MIN. THICK MULTI-PLY FIBERGLASS WITH CONTRASTING CORE COLOR, TWO-COLOR, SCRATCH RESISTANT, NON-STATIC, FIRE RETARDANT, WASHABLE, NON-CORROSIVE, UV INHIBITORS, NON-GLARE SURFACE AND 20 YEAR LIFE EXPECTANCY. FIRE RESISTANT.
 - b. MOUNTING: UNFRAMED, WALL-MOUNTED: MECHANICALLY FASTEN AT BACK, PROVIDE SPACER FOR MOUNTING AT LAP-SIDING WALL FINISH.
 - SIGNAGE TO BE FASTEN TO SUBSTRATE MATERIAL. B. TACTILE AND BRAILLE SIGN: MANUFACTURER'S STANDARD PROCESS FOR PRODUCING TEXT AND SYMBOLS COMPLYING WITH ADA-ABA ACCESSIBILITY GUIDELINES AND WITH ICC/ANSI A117.1. TEXT SHALL BE ACCOMPANIED BY GRADE 2 BRAILLE. PRODUCE PRECISELY FORMED CHARACTERS WITH SQUARE-CUT EDGES FREE FROM BURRS AND CUT MARKS: BRAILLE DOTS WITH DOMED OR ROUNDED SHAPE.
 - 1. PANEL MATERIAL: OPAQUE ACRYLIC SHEET.
- 2. RAISED-COPY THICKNESS: NOT LESS THAN 1/32 INCH (0.8 MM).
- 1.2 ACCESSORIES
 - A. ANCHORS AND INSERTS: PROVIDE NONFERROUS-METAL OR HOT-DIP GALVANIZED ANCHORS AND INSERTS FOR EXTERIOR INSTALLATIONS AND ELSEWHERE AS REQUIRED FOR CORROSION RESISTANCE. USE TOOTHED STEEL OR LEAD EXPANSION-BOLT DEVICES FOR DRILLED-IN-PLACE ANCHORS. FURNISH INSERTS, AS REQUIRED, TO BE SET INTO CONCRETE OR MASONRY WORK.
- 1.3 SUBJECT TO COMPLIANCE WITH REQUIREMENTS, PRODUCTS THAT MAY BE INCORPORATED INTO THE WORK INCLUDE, BUT ARE NOT LIMITED TO, THE **FOLLOWING MANUFACTURERS:**

 - 1. SIGN SYSTEMS (BASIS-OF-DESIGN) 2. ASI SIGNAGE INNOVATIONS
 - 3. ARCHITECTURAL SIGNING
 - 4. OR AN APPROVED EQUAL.



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SPECIFICATIONS 2


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NEW NOTES

- A PROVIDE NEW 8" CMU CHASE WALL. PAINT, GROUT EVERY 3RD CELL. COORD WITH PIPING. THICKEN SLAB AT NEW WALL LOCATIONS INCLUDING REBAR PER STRUCTURAL DWGS. ALL PIPING TO BE INSULATED. ALL HOLLOW CORES IN CMU TO BE FOAMED W/ INSULATION.
- B PROVIDE NEW FLOOR TO RAFTER FULL HEIGHT FRAMED
- SCREEN WALL AND DOOR WALL AT ENTRY DOORS 102 & 104.

WOMENS TOILET 102

TOILET

DEMO PLAN

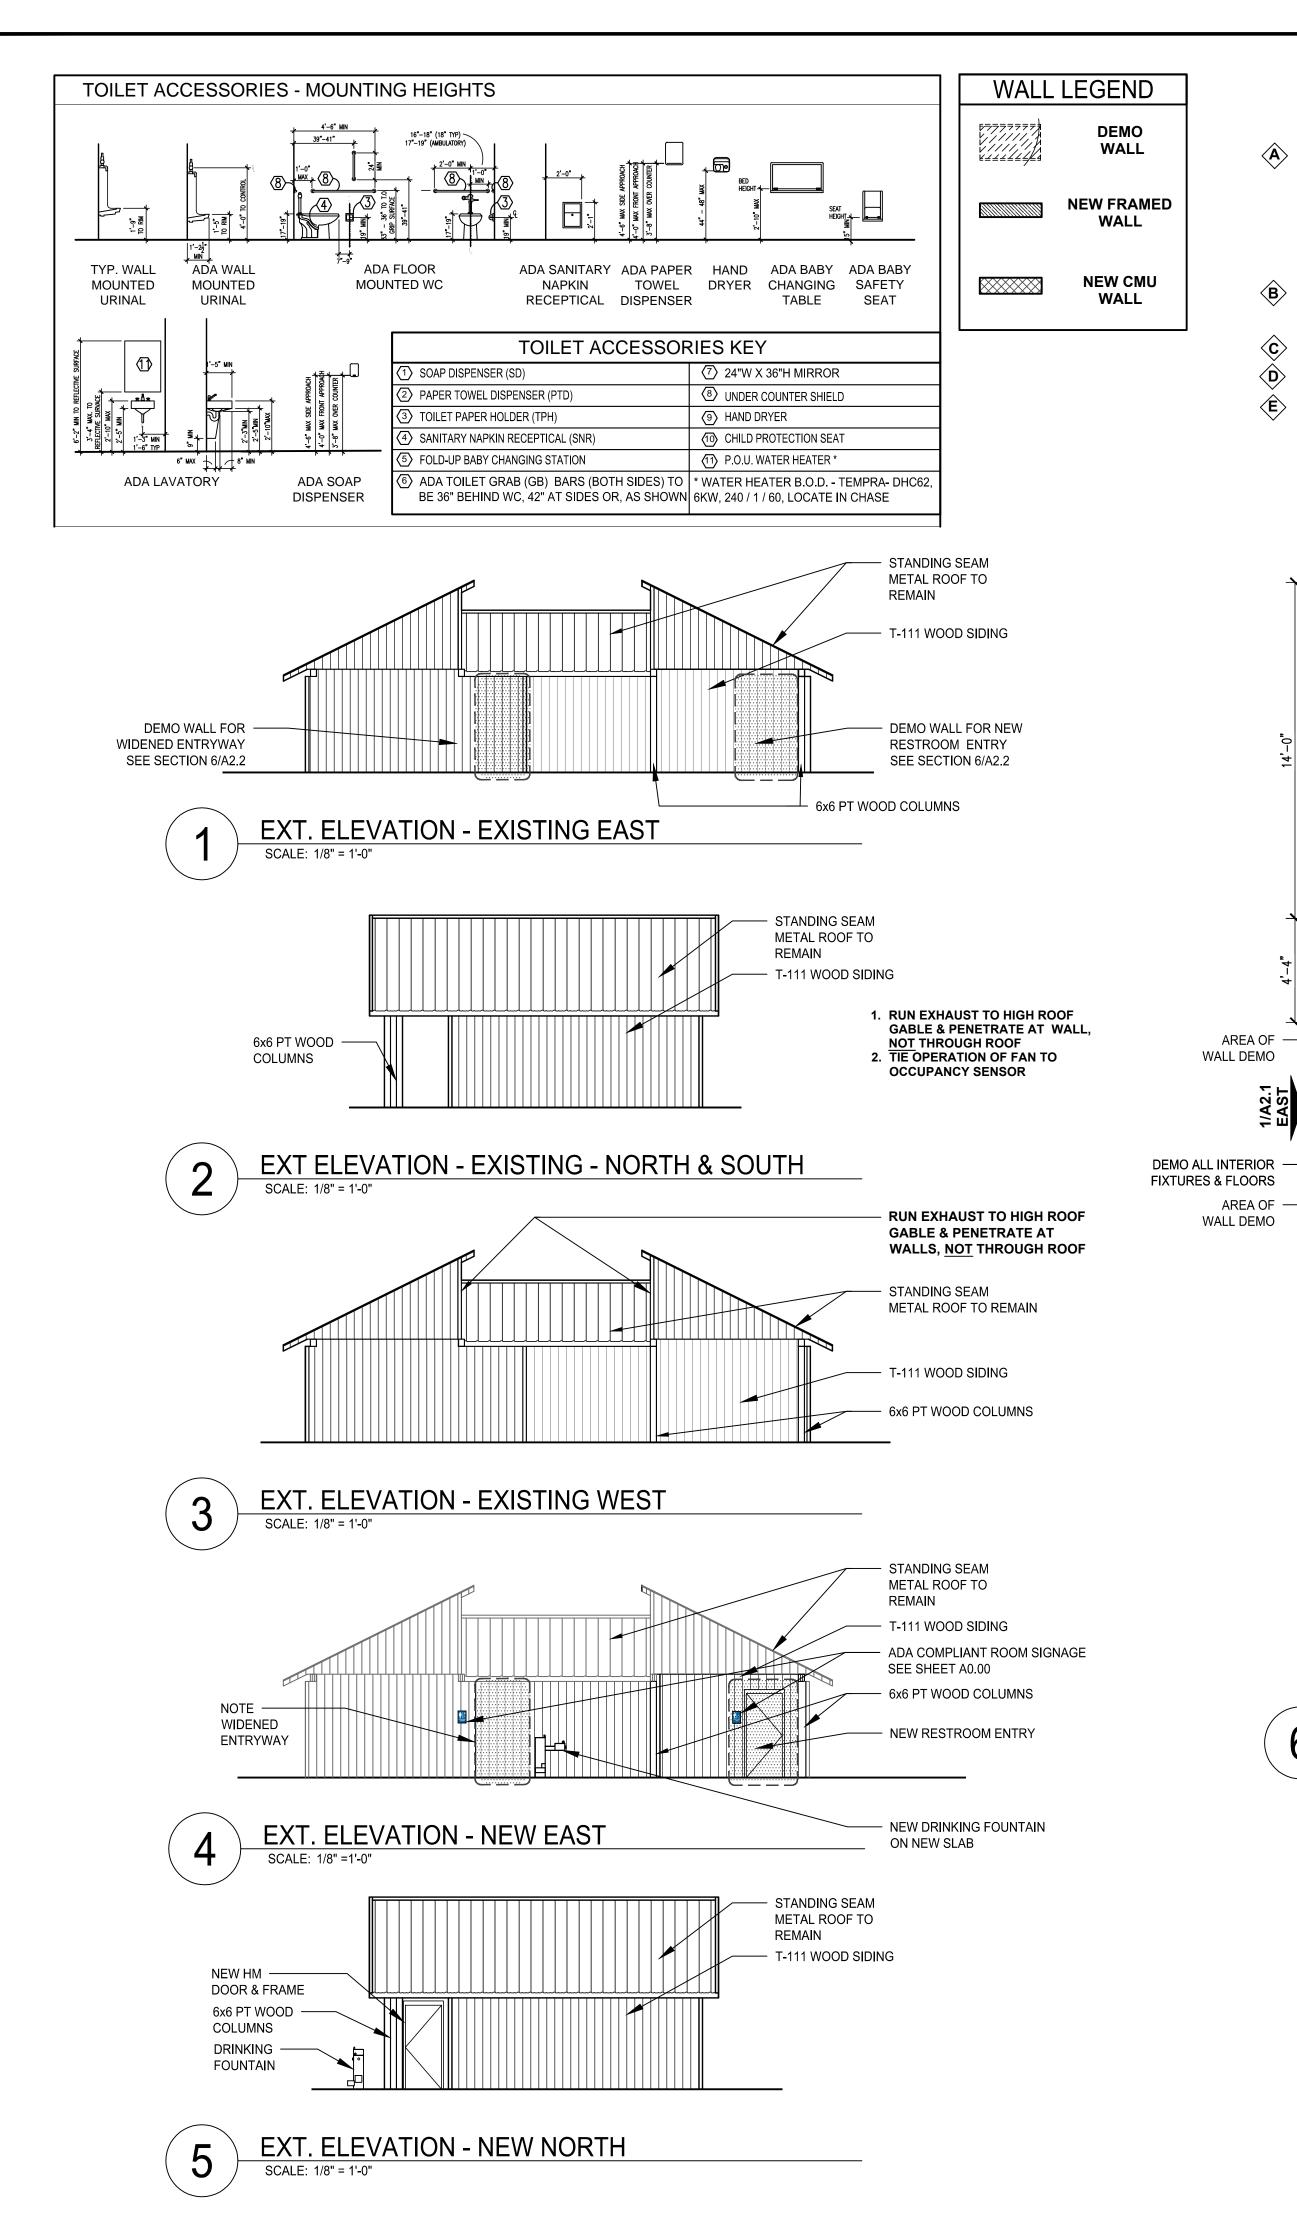DEMO NOTES

DURING REMOVAL.

(3) REMOVE EXISTING FIXTURES.

REMOVE EXISTING IRON GATES AT ENTRIES.

REMOVE CONC. FLOOR AS NECESSARY FOR

EXTENTION OF NEW SERVICE LINES IN FLOOR.

SAW CUT AND REMOVE CMU WALLS AS INDICATED.

BRACE FOR ANY STRUCTURAL LOAD CHANGES

SCALE: 1/8" = 1'-0"

2/A2.1

NORTH

2/A2.1 SOUTH

- C NOT USED
- D PROVIDE 12" PRE-FINISHED METAL CEILING SYSTEM.
- $\langle E \rangle$ PROVIDE ½" PLYWOOD CEILING SOFFIT INTERIOR & EXT. COVER PLYWOOD SEAMS W/ 1X2 FURRING STRIPS. LATEX PAINT.
- F PROVIDE NEW PT 6x6 COLUMN AT ENTRANCE TO WOMENS **SPACE 101 to 102. MATCH EXISTING.**
- PROVIDE SERVICE UTILITY CONNECTIONS / PIPING / TIGHT TO CHASE FLOOR & WALLS.
- (H) INSTALL FIXTURES, ACCESSORIES & PARTITIONS.
- (I) INSTALL (3) NEW HM INSULATED DOORS.
- (J) PAINT FULL HEIGHT OF INTERIOR NEW CMU WALL W/ EPOXY PAINT. MATCH EXISTING WALL FINISH.
- **(K)** PROVIDE NEW FULL HEIGHT OF PARTITION, HEAVY DUTY, STAINLESS STEEL WALL BRACKET FOR URINAL & TOILET PARTITIONS.

DEMO ALL INTERIOR

FIXTURES & FLOORS


ROOM SIGN

ROOM SIGN

101

- (L) PROVIDE NEW, CONTINUOUS 4" RUBBER BASE TO MATCH
- M PROVIDE 3" ROUND BRASS FLOOR DRAIN W/ P-TRAP & TRAP PRIMER, PUMP & POWER, ALL LOCATIONS.
- N HOSE BIBB
- **O** 24" x 24"MOP SINK

18'-4"

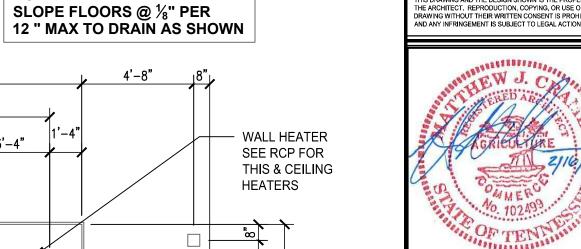

- ROOM

103

8'-8"

LOSE & ASSOCIATES, INC

1314 5th Avenue North, Suite 200 Nashville, Tennessee 37208 (615) 242-0040

220 West Crogan Street, Suite 100

Lawrenceville, Georgia 30046

(770) 338-0017

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RENOVA PREPARED FOR: . OF ENVIRONME ROCK ISLA RESTROOM RENO

NO. DATE COMMENTS

SHEET TITLE FLOOR PLAN -**ELEVATIONS - NOTES** DOOR SCHEDULE

PROJECT NO. DATE 15200.08 02/16/2016 DRAWN BY SCALE BM VARIES CHECKED BY MC SHEET NO.

DOOR SCHEDULE

DOOR	ROOM	DOOMANAME	DOOR						FRAME			HARDWARE		DOOR	
NO:	ROOM NAME		TYPE	WIDTH	HEIGHT	DEPTH	MAT.	FIN.	TYPE	MAT.	FIN.	SET	RATING	FUNCTION	NOTES
	_				-			-						-	
01	102	WOMEN'S RESTROOM	-	3'-0"	7' -0"	2"	НМ	PT	1	НМ	PT	1 - 10	NONE	А	-
02	103	CHASE - PLUMBING	-	3'-0"	7' -0"	2"	НМ	PT	1	НМ	PT	1 - 8	NONE	В	-
03	104	MEN'S RESTROOM	-	3'-0"	7' -0"	2"	НМ	PT	1	НМ	PT	1 - 10	NONE	Α	-

FLOOR PLAN

SCALE: 1/8" = 1'-0"

5/A2.1


NORTH


DOOK FUNCTION OPERATION

COMMENT- B.O.D.- STANLEY & BEST CORES ENTRY & EXIT DEADBOLT STOREROOM

DOO	R HARD	WARE

TEM#	ITEM NAME	BASIS OF DESIGN	ITEM #	COLOR	COMMENT
1.	CYLINDER	BEST	1E62C4RP3	612 FINISH	ALL LOCATIONS - THUMB TURN ON INTERIOR SIDE
2.	SILENCER	ROCKWOOD	608	GREY	ALL LOCATIONS, 3 PER DOOR
3.	JAMB SEAL	PEMKO	316AS	ALUMINUM	
4.	DOOR SHOE	PEMKO	210APK/211APK	ALUMINUM	EXTERIOR DOORS ONLY - USE 210APK
5.	THRESHOLD	NATIONAL GUARD	896S	ALUMINUM	½" HIGH X 5" WIDE ADA COMPLIANT UNIT WITH SILICONE INSERT
6.	WALL STOP	ROCKWOOD	RM861	US32 STAINLESS STEEL	AS INDICATED
7.	DOOR CLOSER	YALE	SI SERIES	ALUMINUM	ALUMINUM COVER
8.	LATCH GUARD	DON-JO	SLP106	STAINLESS STEEL	PROVIDE AT DOOR LEVER AND DEADBOLT
9.	PULL PLATE	HAGER	33G	ALUMINUM	4" x 16"
10.	PUSH PLATE	HAGER	33S	ALUMINUM	4" x 16"

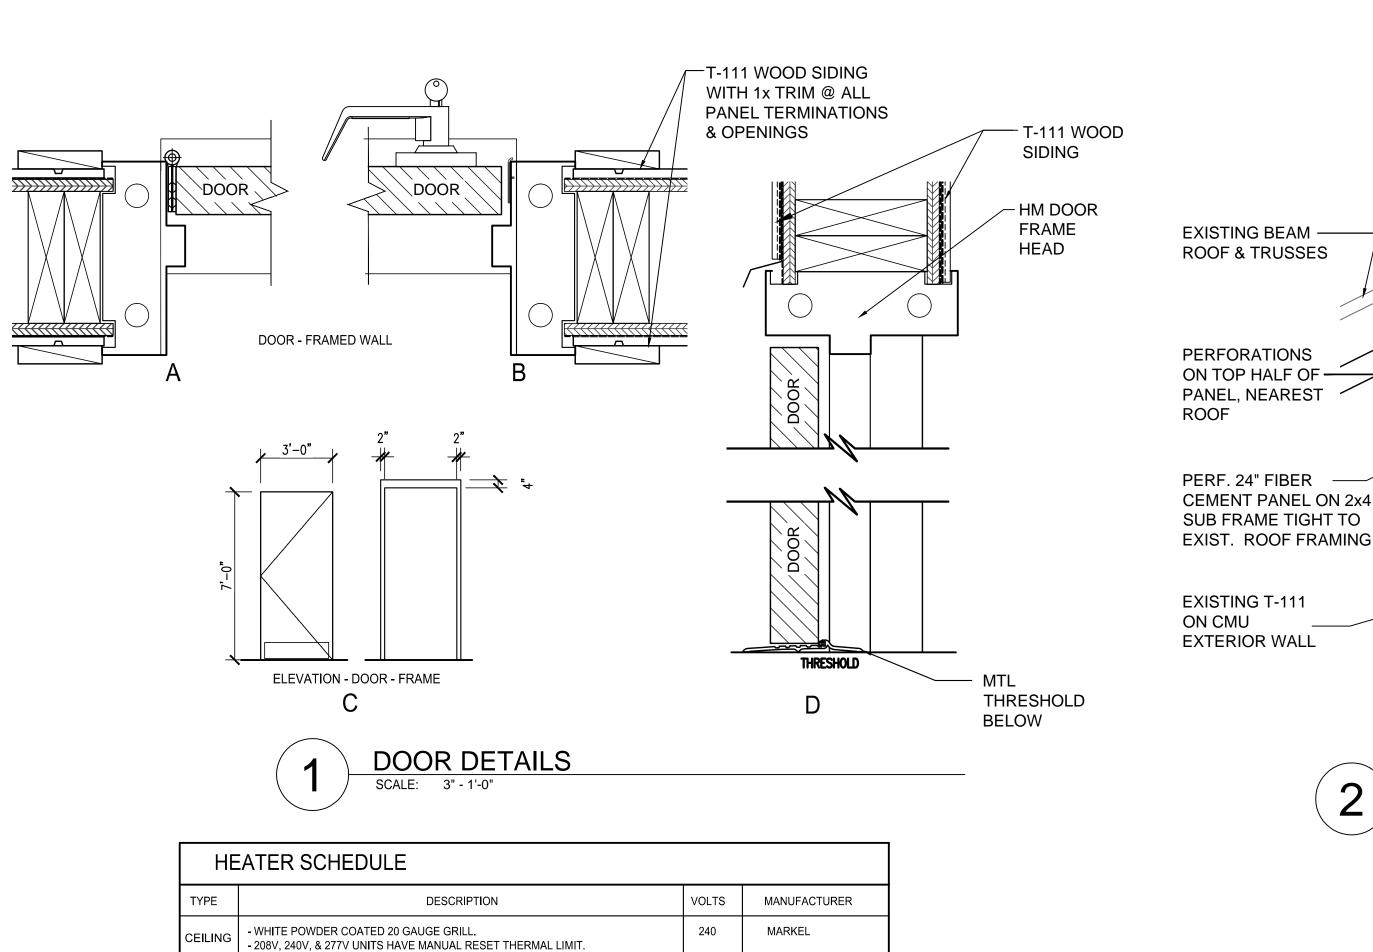

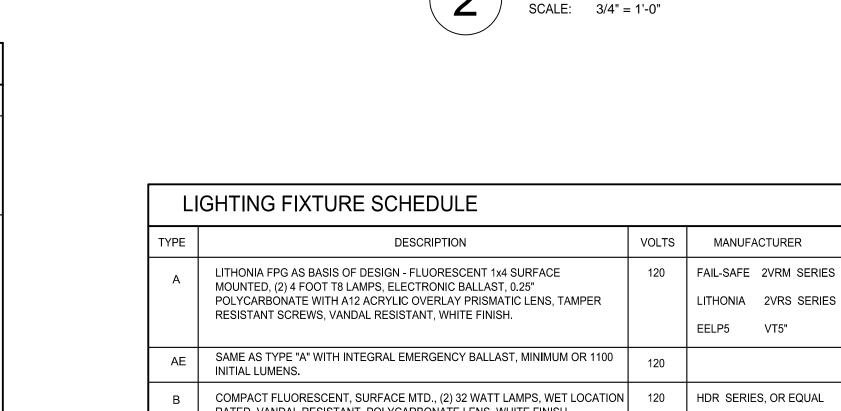

ROOF & TRUSSES

PERFORATIONS

CEMENT PANEL ON 2x4

COMPACT FLUORESCENT, SURFACE MTD., (2) 32 WATT LAMPS, WET LOCATION | 120 | HDR SERIES, OR EQUAL RATED, VANDAL RESISTANT, POLYCARBONATE LENS, WHITE FINISH. 6. ALL FIXTURES TO BE WHITE IN COLOR. ALL FIXTURES TO BE SUPPLIED WITH LAMPS. FIXTURES SHALL BE COMPATIBLE WITH CEILING TYPE. 7. PROVIDE 2 OCCUPANCY SENSORS TO THE CEILING OF - BATT INSULATION EACH RESTROOM. ONE (1) WALL SENSOR TO BE REFER TO ARCHITECTURAL DRAWINGS FOR FIRE PROVIDED ON UTILITY ROOM WALL. - NEW 8" CMU WALL ALL FIXTURES INSTALLED IN AN INSULATED CEILING 8. PROVIDE LIGHT SENSOR TO ACTIVATE EXT. LIGHTING & — NEW HM DOOR 4. ALL FIXTURES TO BE WET RATED & HAVE BUG PROOF 9. PROVIDE PRISMATIC TEMPERED GLASS WITH CLEAR OVERLAY FOR TYPE "G" FIXTURE POLYCARBONATE. 5. BOXES & HOUSING GASKETS.

TOILET PARTITION—	- NEW HM DOOR
8-52	
	— NEW TOILET FIXTURES
BUILDING SECTION	— THICKENED SLAB FOR NEW CMU WALL

- 480V UNITS HAVE MANUAL RESET THERMAL LIMIT, 24V CONTROL

• POWDER COATED BAR STOCK STEEL TAMPER PROOF GRILLE, WITH EXTRUDED

CORROSION RESISTANT STEEL TUBULAR ELEMENT WITH BRAZED STEEL FINS.

• IN-BUILT DOUBLE POLE TAMPER PROOF THERMOSTAT WITH A 40°-110°F

TEMPERATURE RANGE & POSITIVE OFF; 3 PHASE HEATERS HAVE 3 POLE

• PERMANENTLY LUBRICATED, UNIT BEARING, SHADED POLE MOTOR WITH

TRANSFORMER, AND 24V RELAY (A1 SUFFIX).

ALUMINUM FRAME AND 16 GAUGE HOUSING.

THERMOSTAT FOR POSITIVE OFF POSITION.

MANUAL RESET THERMAL LIMIT SWITCH.

IMPEDANCE PROTECTION.

• PROPELLER TYPE FAN BLADE:

• FACTORY INSTALLED OPTIONS:

CONTACTORS (3420 & 3450 SERIES)

- CIRCUIT BREAKERS (3450 SERIES) - CONTROL TRANSFORMERS (3450 SERIES)


1400 RPM MOTOR; 245 CFM

BATT INSULATION —


NEW CMU WALL-

- ROUGH IN DIMENSIONS: 23-1/16" SQ. X 9-1/8" DEEP.

- ENCLOSED STEEL FIN SHEATH ELEMENT.

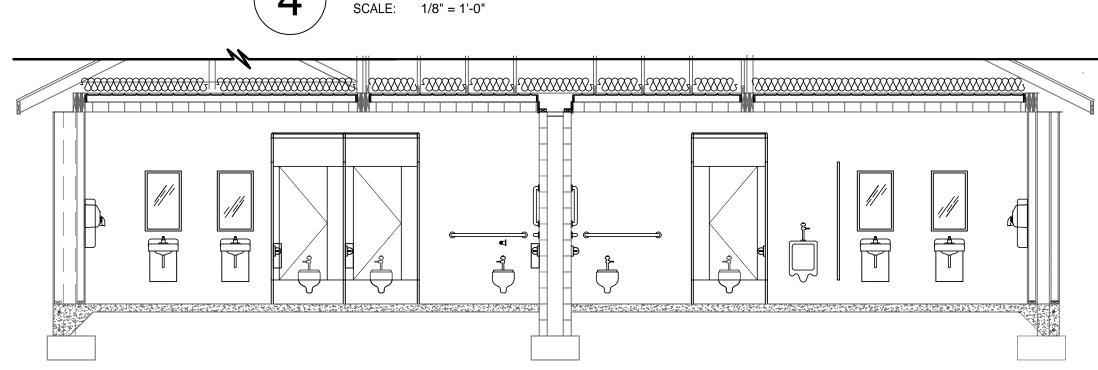



BUILDING SECTION - INT. ELEVATION SCALE:

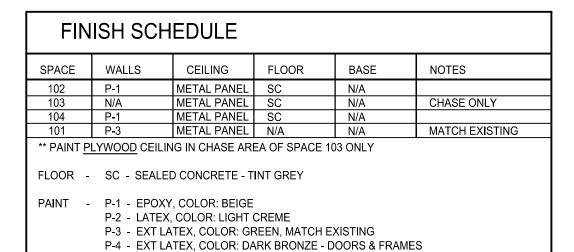

EAVE SECTION

MANUFACTURER

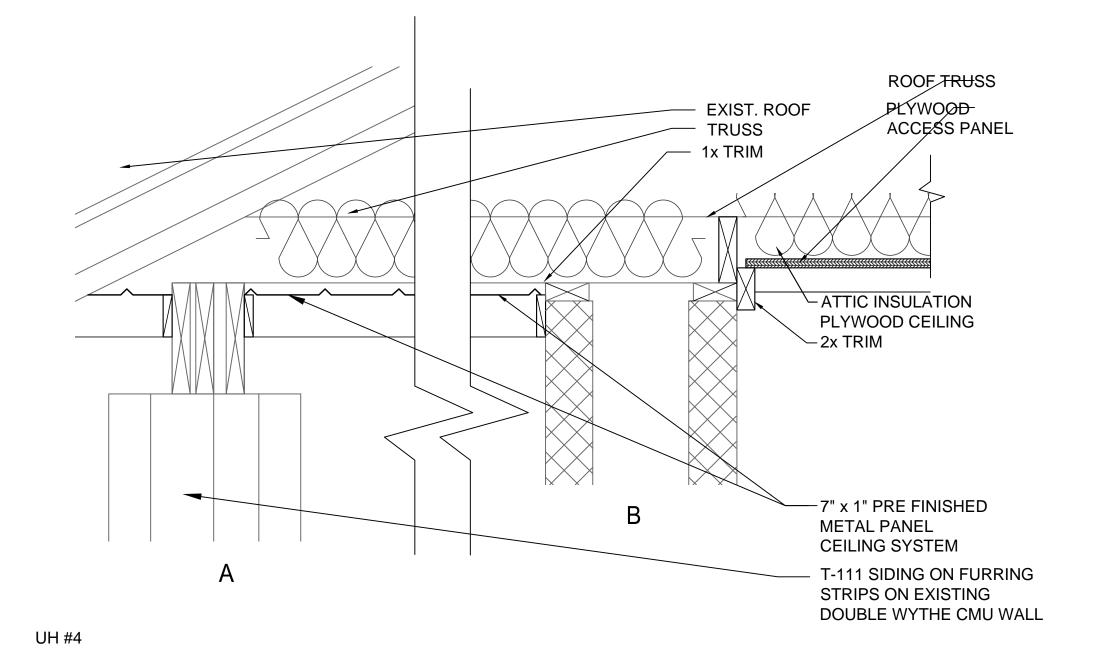


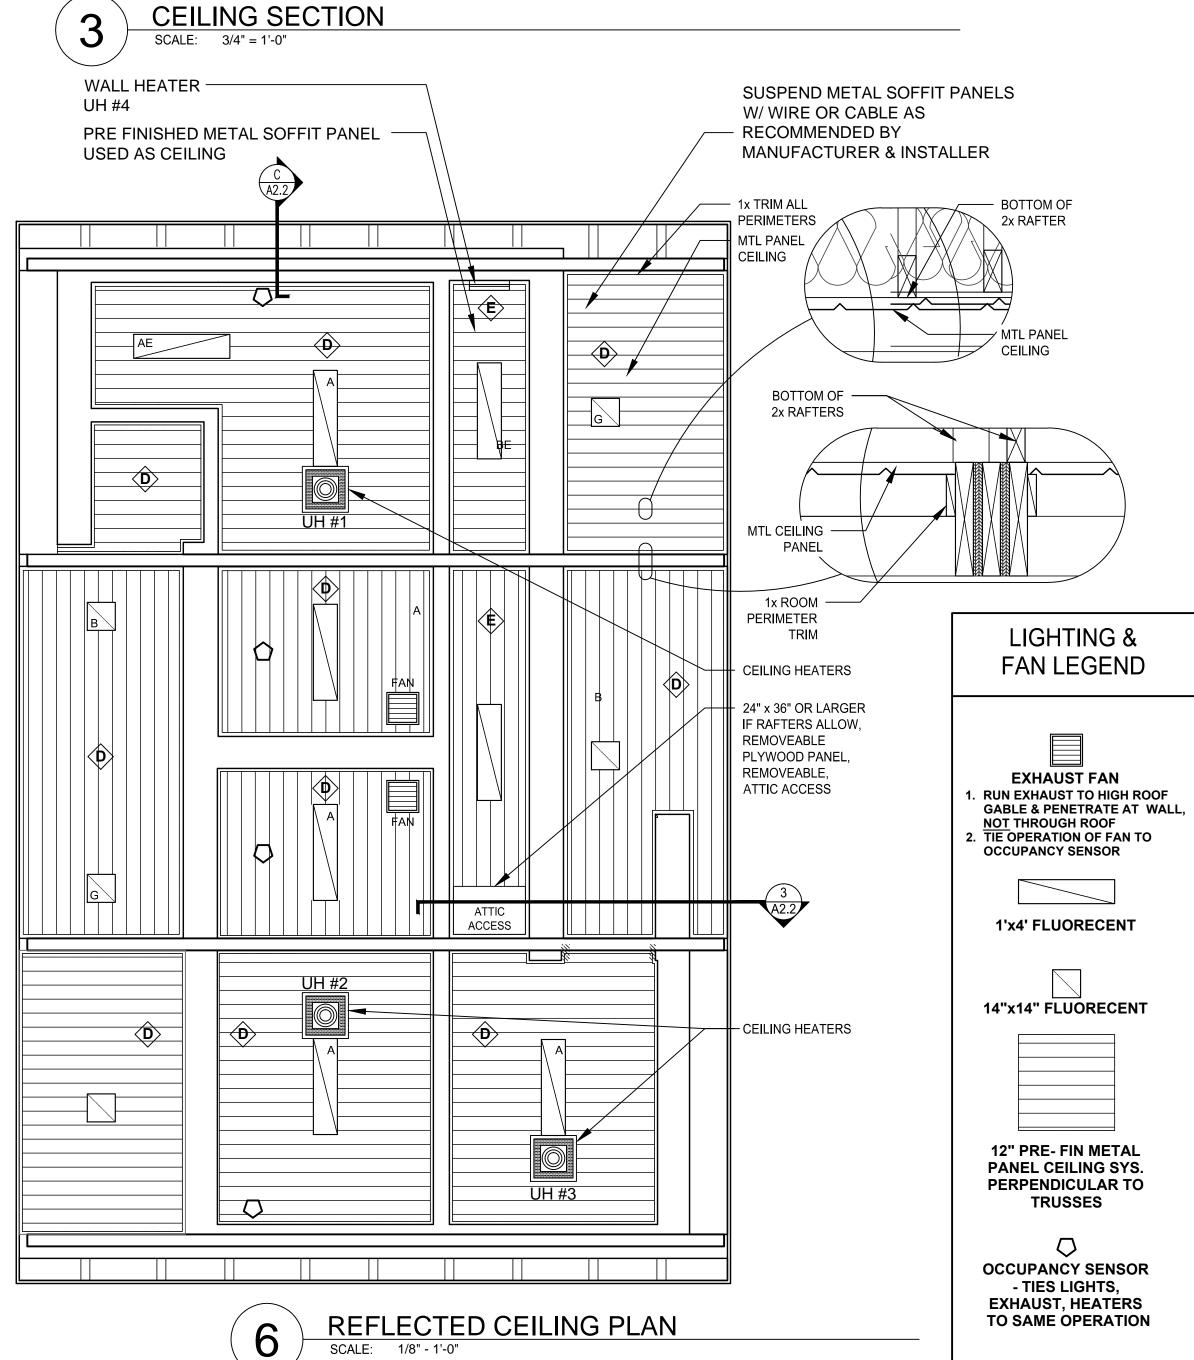



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RENOVA \forall

ROCK ISLARESTROOM RENO

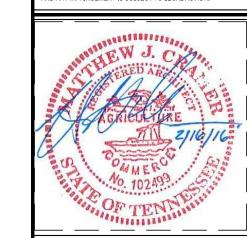NO. DATE COMMENTS SHEET TITLE SECTIONS - DETAILS PROJECT NO. DATE

02/16/2016

VARIES

SCALE


15200.08

CHECKED BY MC

SHEET NO.

DRAWN BY

BM

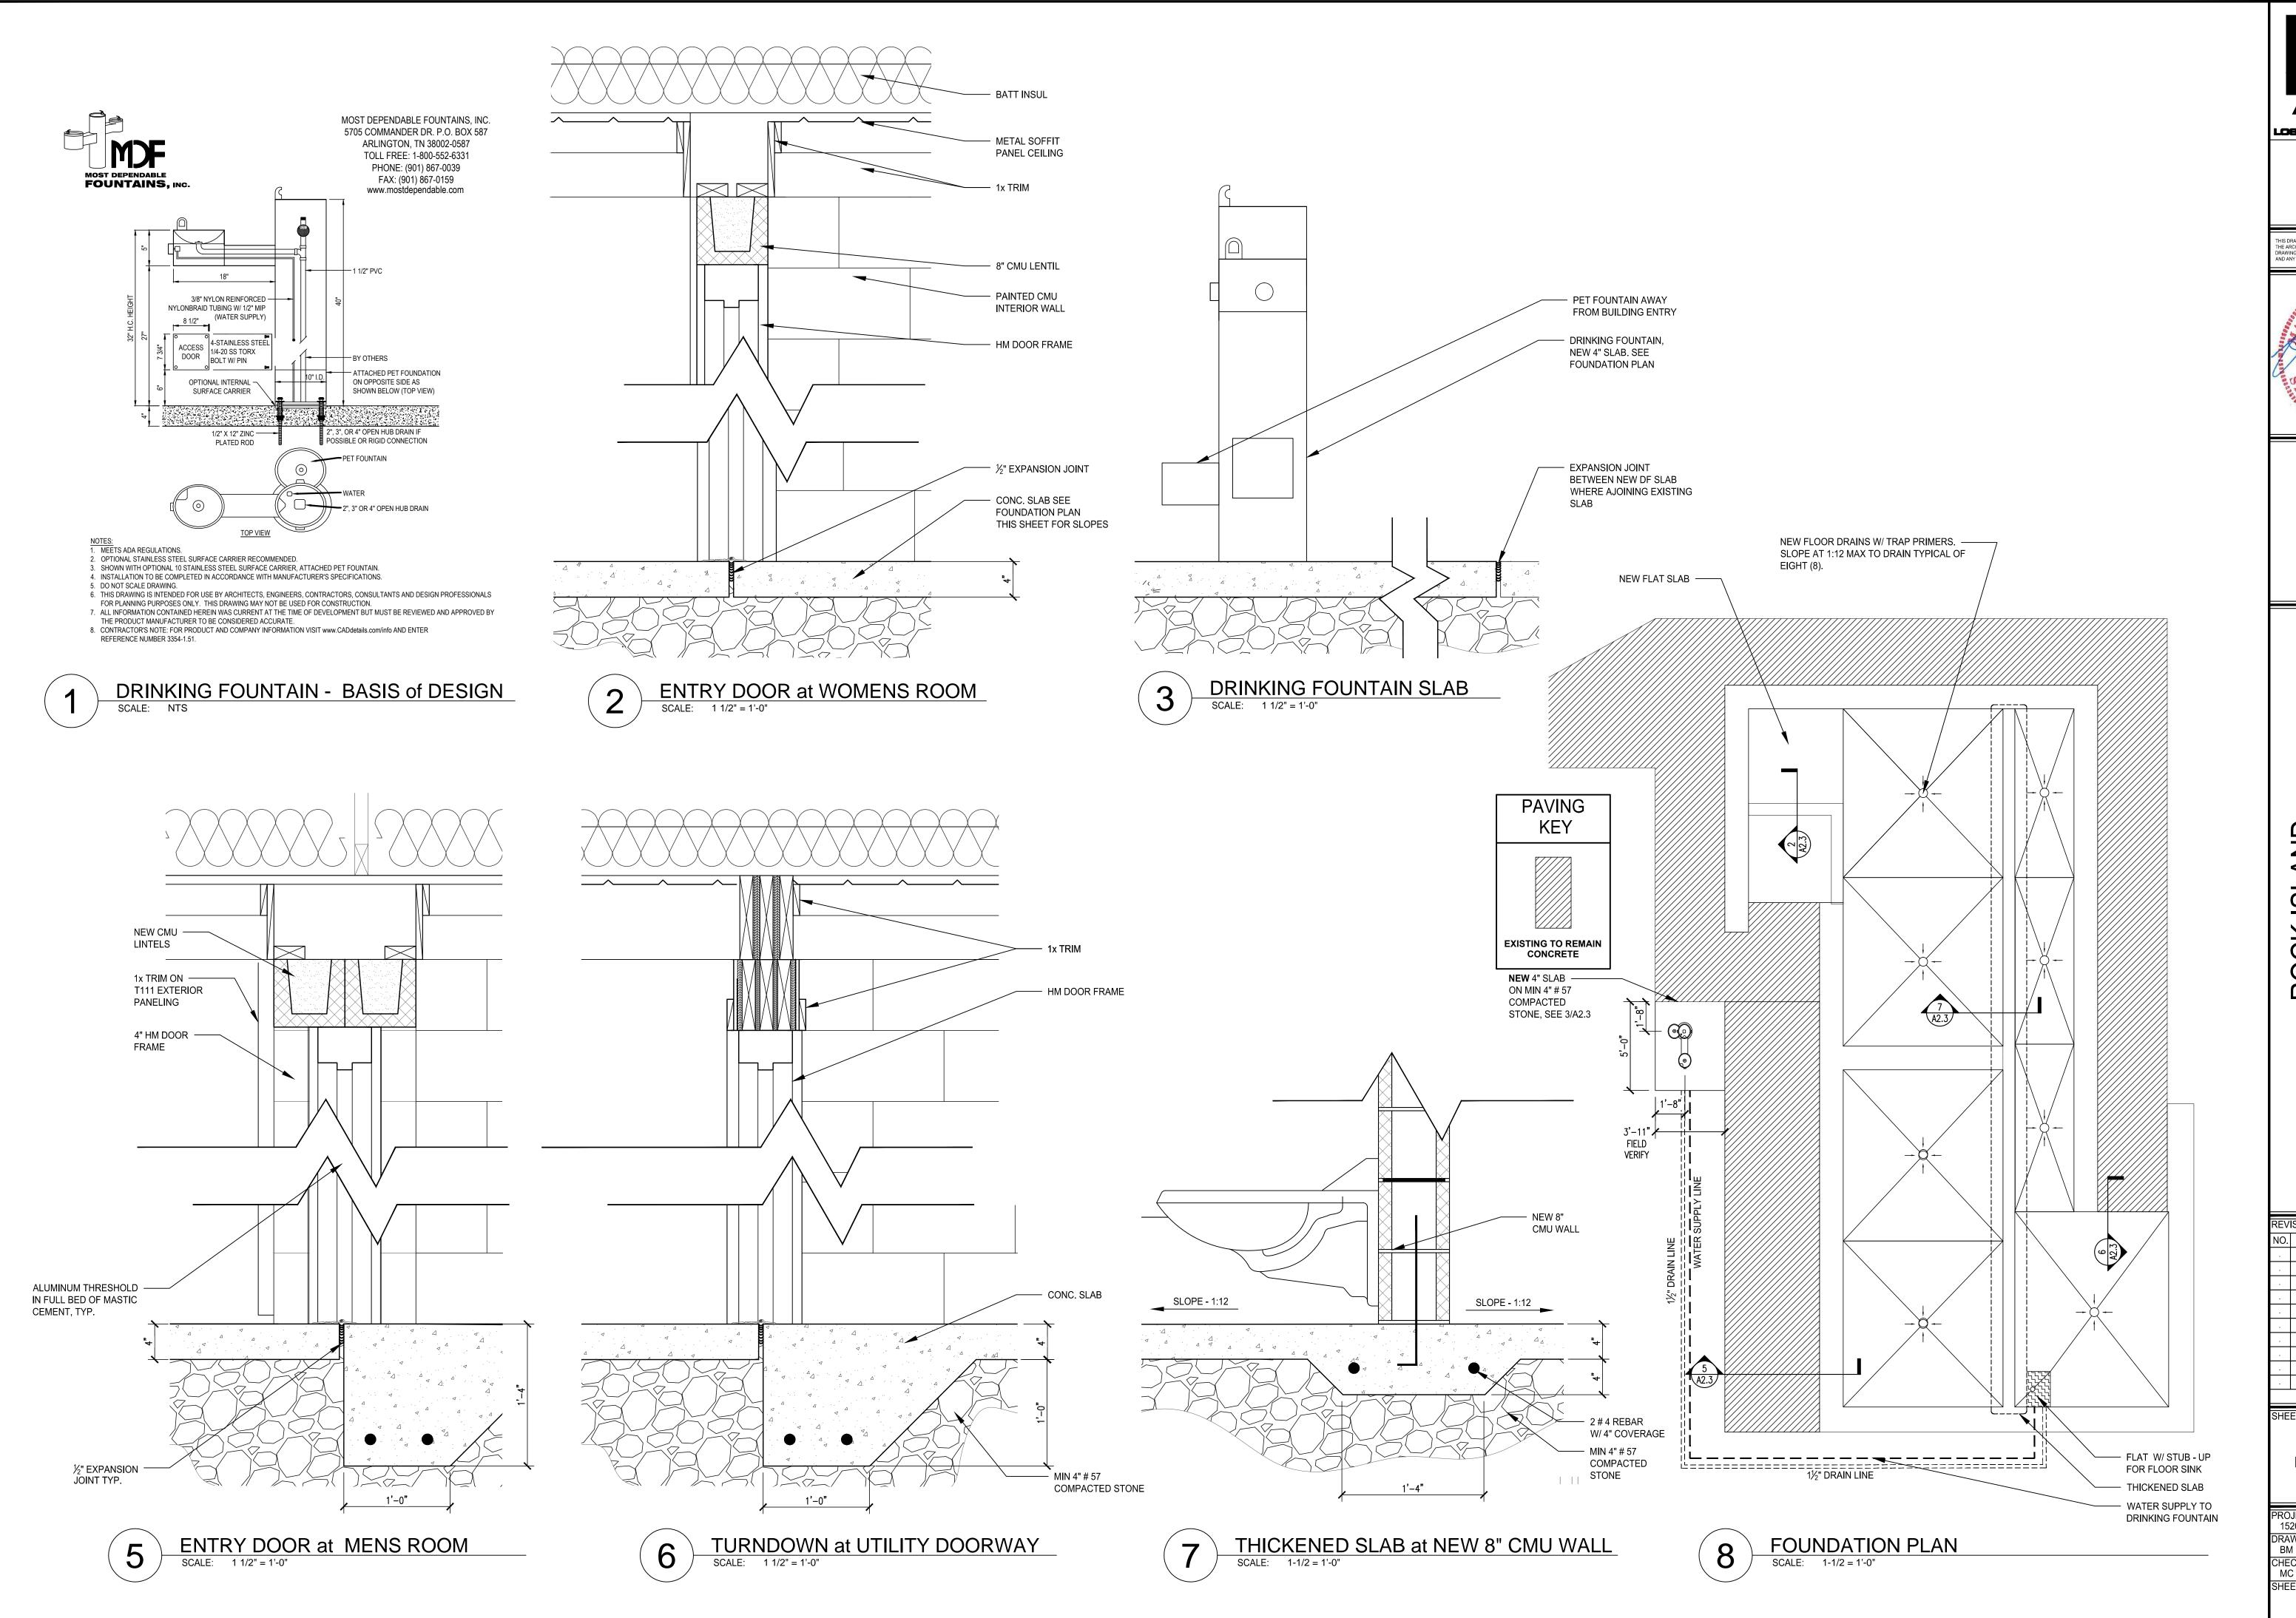

LOSE & ASSOCIATES, INC.

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ROCK ISLANI
RESTROOM RENOVAT

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ΙE	ET TITLE	

FOUNDATION PLAN - SECTIONS **DETAILS**

PROJECT NO. DATE 15200.08 02/16/2016 SCALE DRAWN BY BM CHECKED BY MC SHEET NO. A2.3